## THE CITY OF SOUTH LEBANON WARREN COUNTY, OHIO


## RIVER CORRIDOR PUBLIC SANITARY SEWER EXTENSION

## **BENCHMARKS**

BM#	DESCRIPTION	ELEVATION	NORTHING	EASTING
	IRON PIPE LOCATED AT THE			
	NORTHWEST CORNER OF MAIN			
100	STREET AND BAYOU STREET	630.47	502237.98	1482707.17
104	NAIL SET IN ASPHALT PATH	630.40	502052.22	1483405.36
107	NAIL SET IN ASPHALT PATH	627.61	501671.97	1484505.27
110	NAIL SET IN ASPHALT PATH	630.12	501234.82	1485584.46
114	NAIL SET IN ASPHALT PATH	628.17	501071.44	1487064.47
121	NAIL SET IN ASPHALT PATH	633.04	502305.29	1476557.39
124	NAIL SET IN ASPHALT PATH	629.90	501695.37	1477258.79
128	NAIL SET IN ASPHALT PATH	628.12	502103.84	1478536.75
132	NAIL SET IN ASPHALT PATH	626.56	502183.43	1479852.52
135	NAIL SET IN ASPHALT PATH	627.46	502630.42	1480879.84
138	NAIL SET IN ASPHALT PATH	627.42	502468.14	1481981.24
6374	NAIL SET IN ASPHALT PATH	689.28	503541.43	1476501.50
	·			

## **CONTROL BASIS:**

THE BEARINGS ARE BASED ON US STATE PLANE NAD 83 (OHIO SOUTH ZONE 3402). ELEVATIONS BASED ON NAVD88. BOTH DERIVED FROM ODOT'S VRS RTK NETWORK USING STATIONS OHDT AND LEBA.

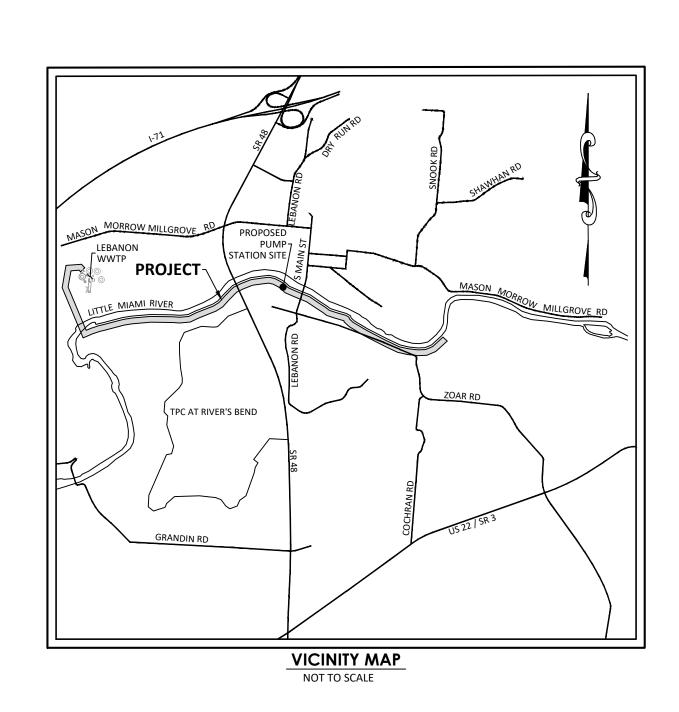


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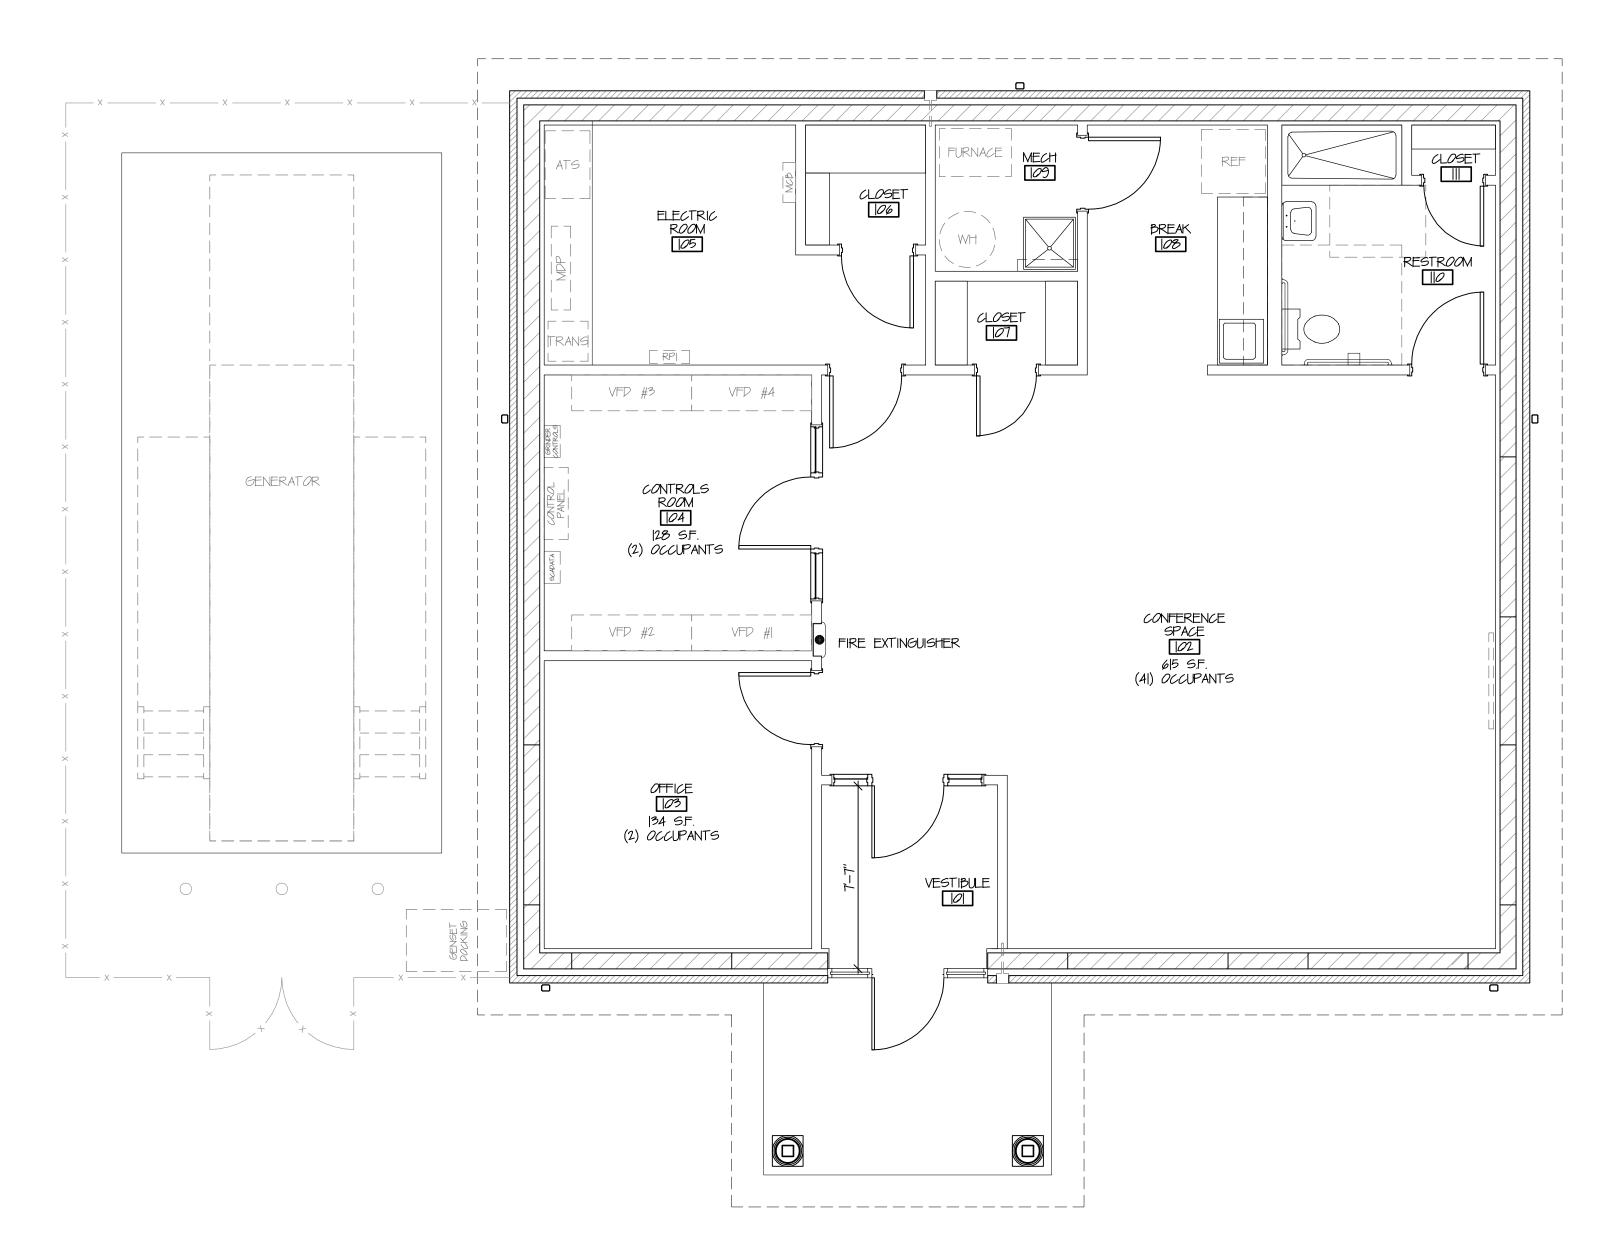
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**COVER SHEET** 

06308

06308.12 **Sheet Number** 

Project Number Drawing Scale

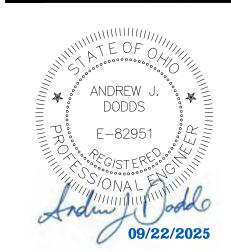

**CODE PLAN** 



## CODE NOTES

THIS PROJECT IS A NEW 1-STORY BUILDING TO CONTAIN POWER AND CONTROLS FOR A LARGE SANITARY FORCE MAIN. IT WILL ALSO HAVE AN OFFICE, MEETING AREA, BREAK AREA AND RESTROOM. THE FORCE MAIN WILL OPERATE 24/7/365 AND SERVICE AND MAINTENANCE PERSONNEL WILL OCCUPY THIS BUILDING TO ASSURE THE FORCE MAIN IS OPERATIONAL. ON A TYPICAL PAY, THERE WILL BE ONE PERSON IN THE OFFICE MONITORING OPERATIONS. THE CITY OF SOUTH LEBANON WILL USE THE CONFERENCE SPACE OCCASSIONALLY FOR MEETINGS WITH INTERNAL OR EXTERNAL PERSONNEL. THE RESTROOM AND SHOWER WILL BE USED BY CITY PERSONNEL ONLY.

BUILDING CONSTRUCTION TYPE: V-B

BUILDING USE IS "B" — BUSINESS

TOTAL BUILDING AREA: 1,580 S.F.

ALLOWABLE BUILDING HEIGHT (OBC 504.3) - 40'

ALLOWABLE NUMBER OF STORIES (OBC 504.4) - TWO (2)

ALLOWABLE BUILDING AREA (OBC 506.2) - 9,000 SF

ACTUAL HEIGHT / STORIES / AREA = 20-7" / | STORY / 1,580 SF OCCUPANT LOADING (OBC 1004.1.2)

CONFERENCE SPACE - 6/5 SF AT 15/NET = 4/1 OCC. OFFICE |03 - |34 SF AT |00/6R0SS = 2 OCC.CONTROLS ROOM - |28 SF AT |00/6ROSS| = 2 OCC.TOTAL OCCUPANTS - 45

AN ACCESSIBLE UNISEX RESTROOM IS PROVIDED FOR CITY PERSONNEL USE ONLY - THIS BUILDING IS NOT OPEN TO THE GENERAL PUBLIC.

A NATURAL GAS GENERATOR IS BEING PROVIDED TO ENSURE THE FORCE MAIN WILL REMAIN OPERATIONAL 24/7/365.

FIRE EXTINGUISHERS WILL BE PROVIDED TO MEET OBC 906.3

BUILDING IS NOT EQUIPPED WITH AN AUTOMATIC SPRINKLER SYSTEM.

BUILDING DOES NOT HAVE A FIRE ALARM SYSTEM AND IS NOT REQUIRED PER OBC 907.2.2. EGRESS:

BUILDING HAS (1) EXIT AND MEETS EGRESS REQUIREMENTS PER OBC 1006.2.1 - OCCUPANT LOAD DOES NOT EXCEED 49 - MAXIMUM COMMON PATH OF EGRESS DOES NOT EXCEED 75'

BUILDING EXIT IS ACCESSIBLE AND AT GRADE

DOOR HARDWARE WILL PERMIT EGRESS AT ALL TIMES WITHOUT THE USE OF A KEY OR SPECIAL KNOWLEDGE

EXIT ACCESS TRAVEL DISTANCE IS LESS THAN 200' AND CONFORMS WITH OBC 1017.2.



Architecture 3700 Park 42 Drive ■ Engineering Suite 190B ■ Landscape Architecture Cincinnati OH 45241 Phone 513.759.0004 ■ Surveying www.mspdesign.com

Project Manager CSW Drawn By 06308121-4A1 X-Ref(s) NONE

Planning

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Exp. Date 12/31/25

CITY STREET


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CODE NOTES

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06308.12 AS NOTED



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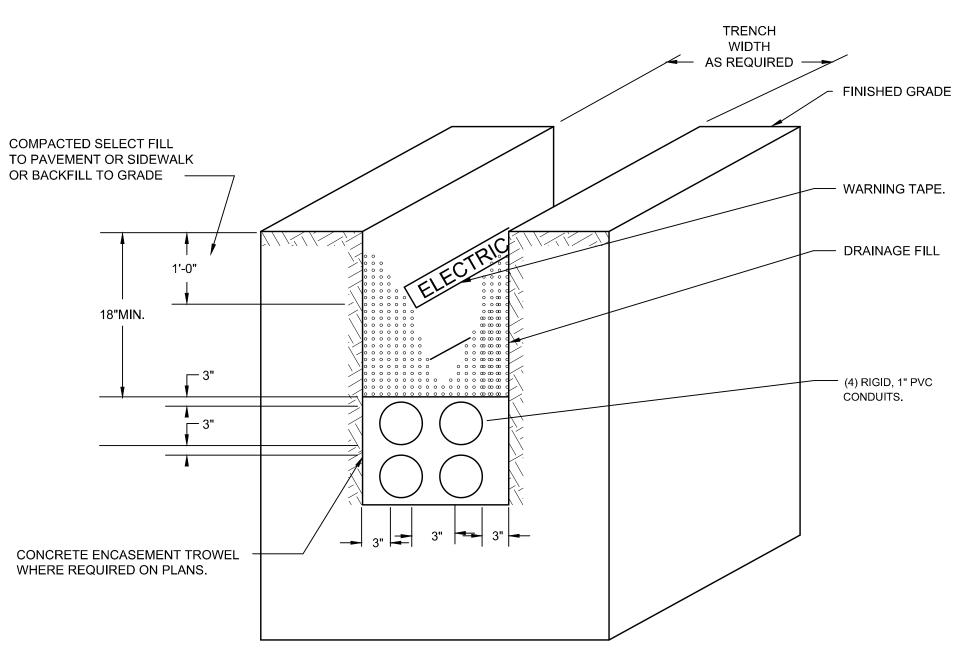
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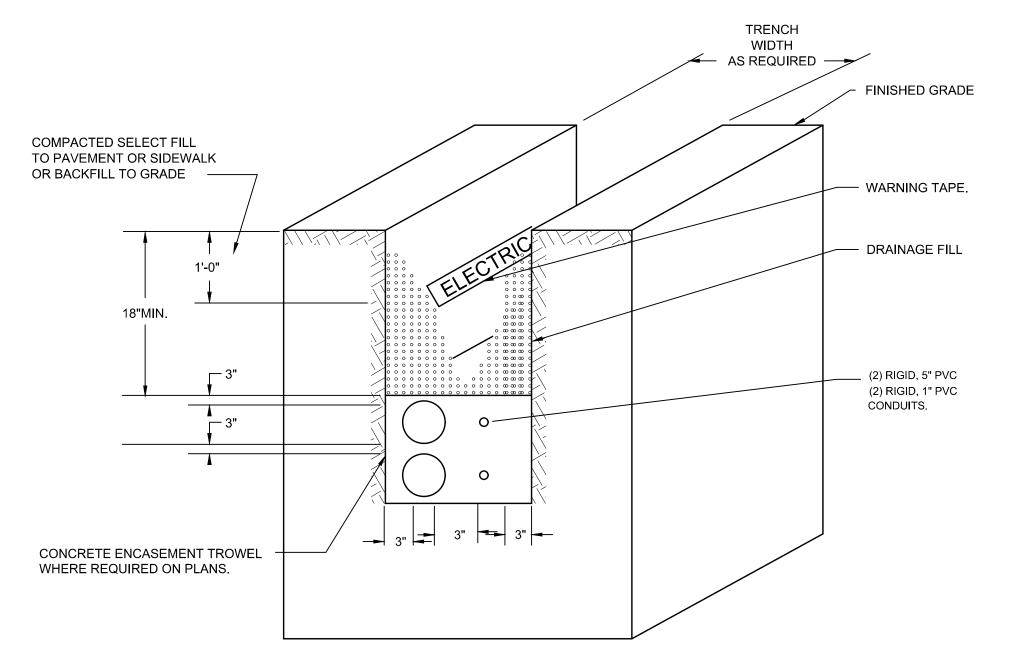
Sheet Title ELECTRICAL LIGHTING, POWER, & FIRE ALARM FLOOR PLAN

Project Number Drawing Scale Sheet Number

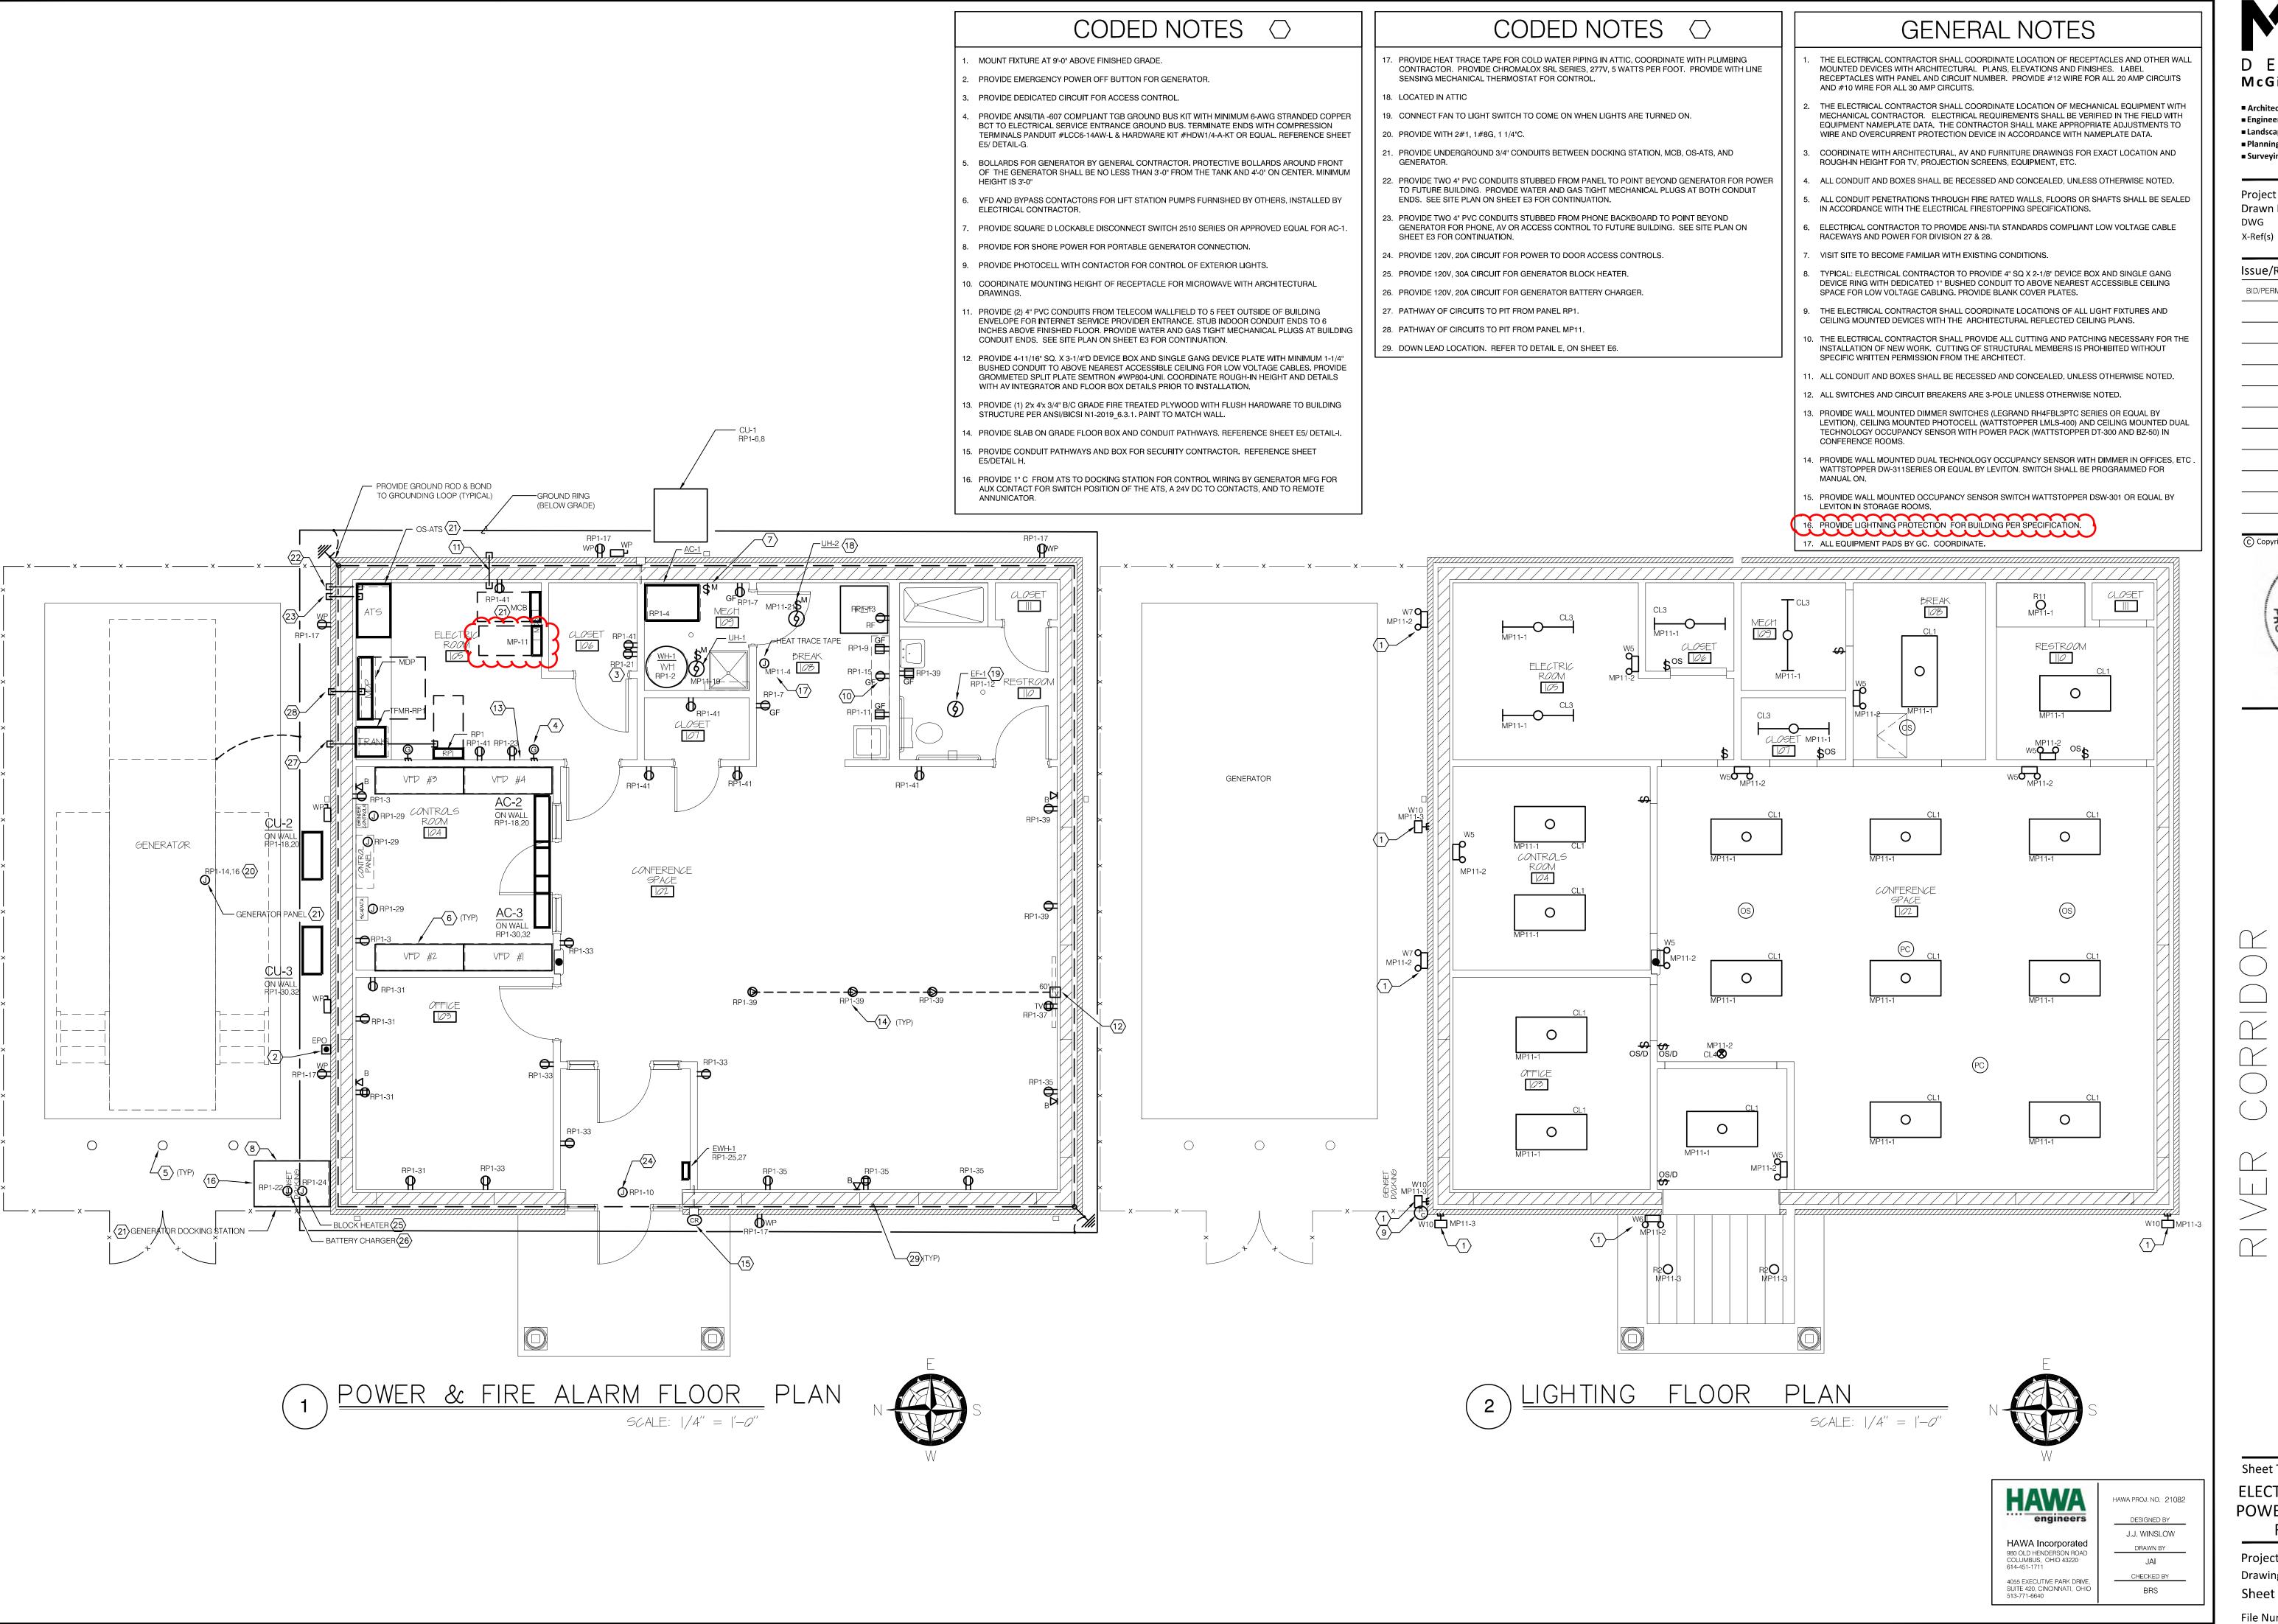
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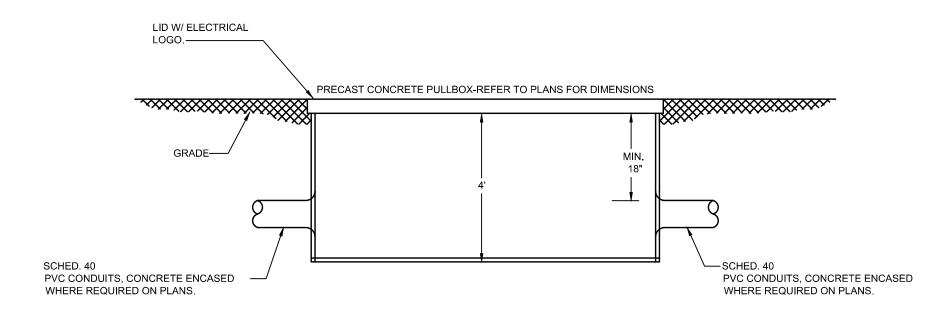





ELECTRICAL DUCT BANK DETAIL-EAST






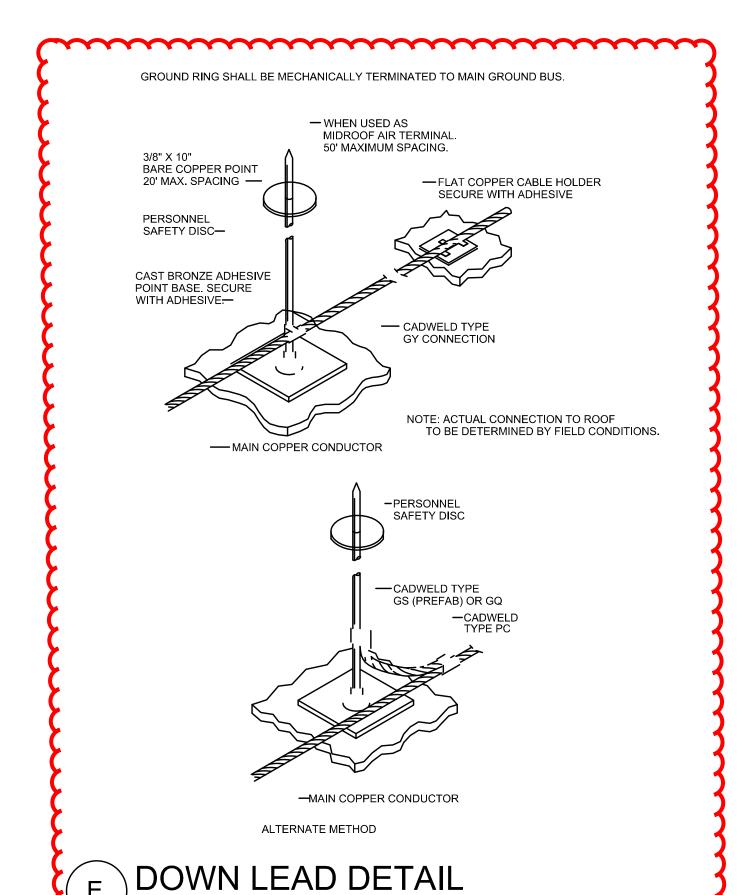

C ELECTRICAL PULLBOX DETAIL

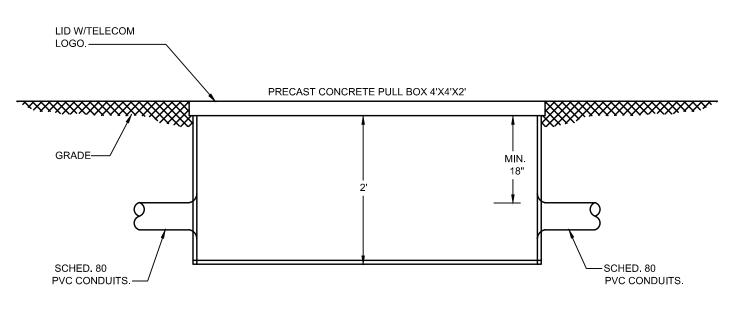

TELECOM PULLBOX DETAIL

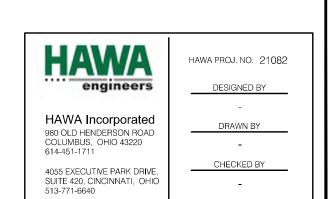

ELECTRICAL DETAILS Project Number Drawing Scale

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E6 ELECTRICAL DETAILS


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## DRAWING NOTES - CEILING PLAN


CONTROLS
ROOM
104

5/8" GYPSUM BOARD CEILING INSTALLED ON BOTTOM OF ROOF TRUSSES


(2) E.I.F.S. BULKHEAD - SEE SECTIONS

- (3) PREFINISHED S.M. SOFFIT PANELS
- *O*F ADJACENT WALL
- PROVIDE MINIMUM 20" x 30" ACCESS HATCH TO ATTIC SPACE LOCATE ACCESS HATCH CENTERED BETWEEN TRUSSES
- (7) SURFACE MOUNTED LIGHTING SEE ELECTRICAL DRAWINGS
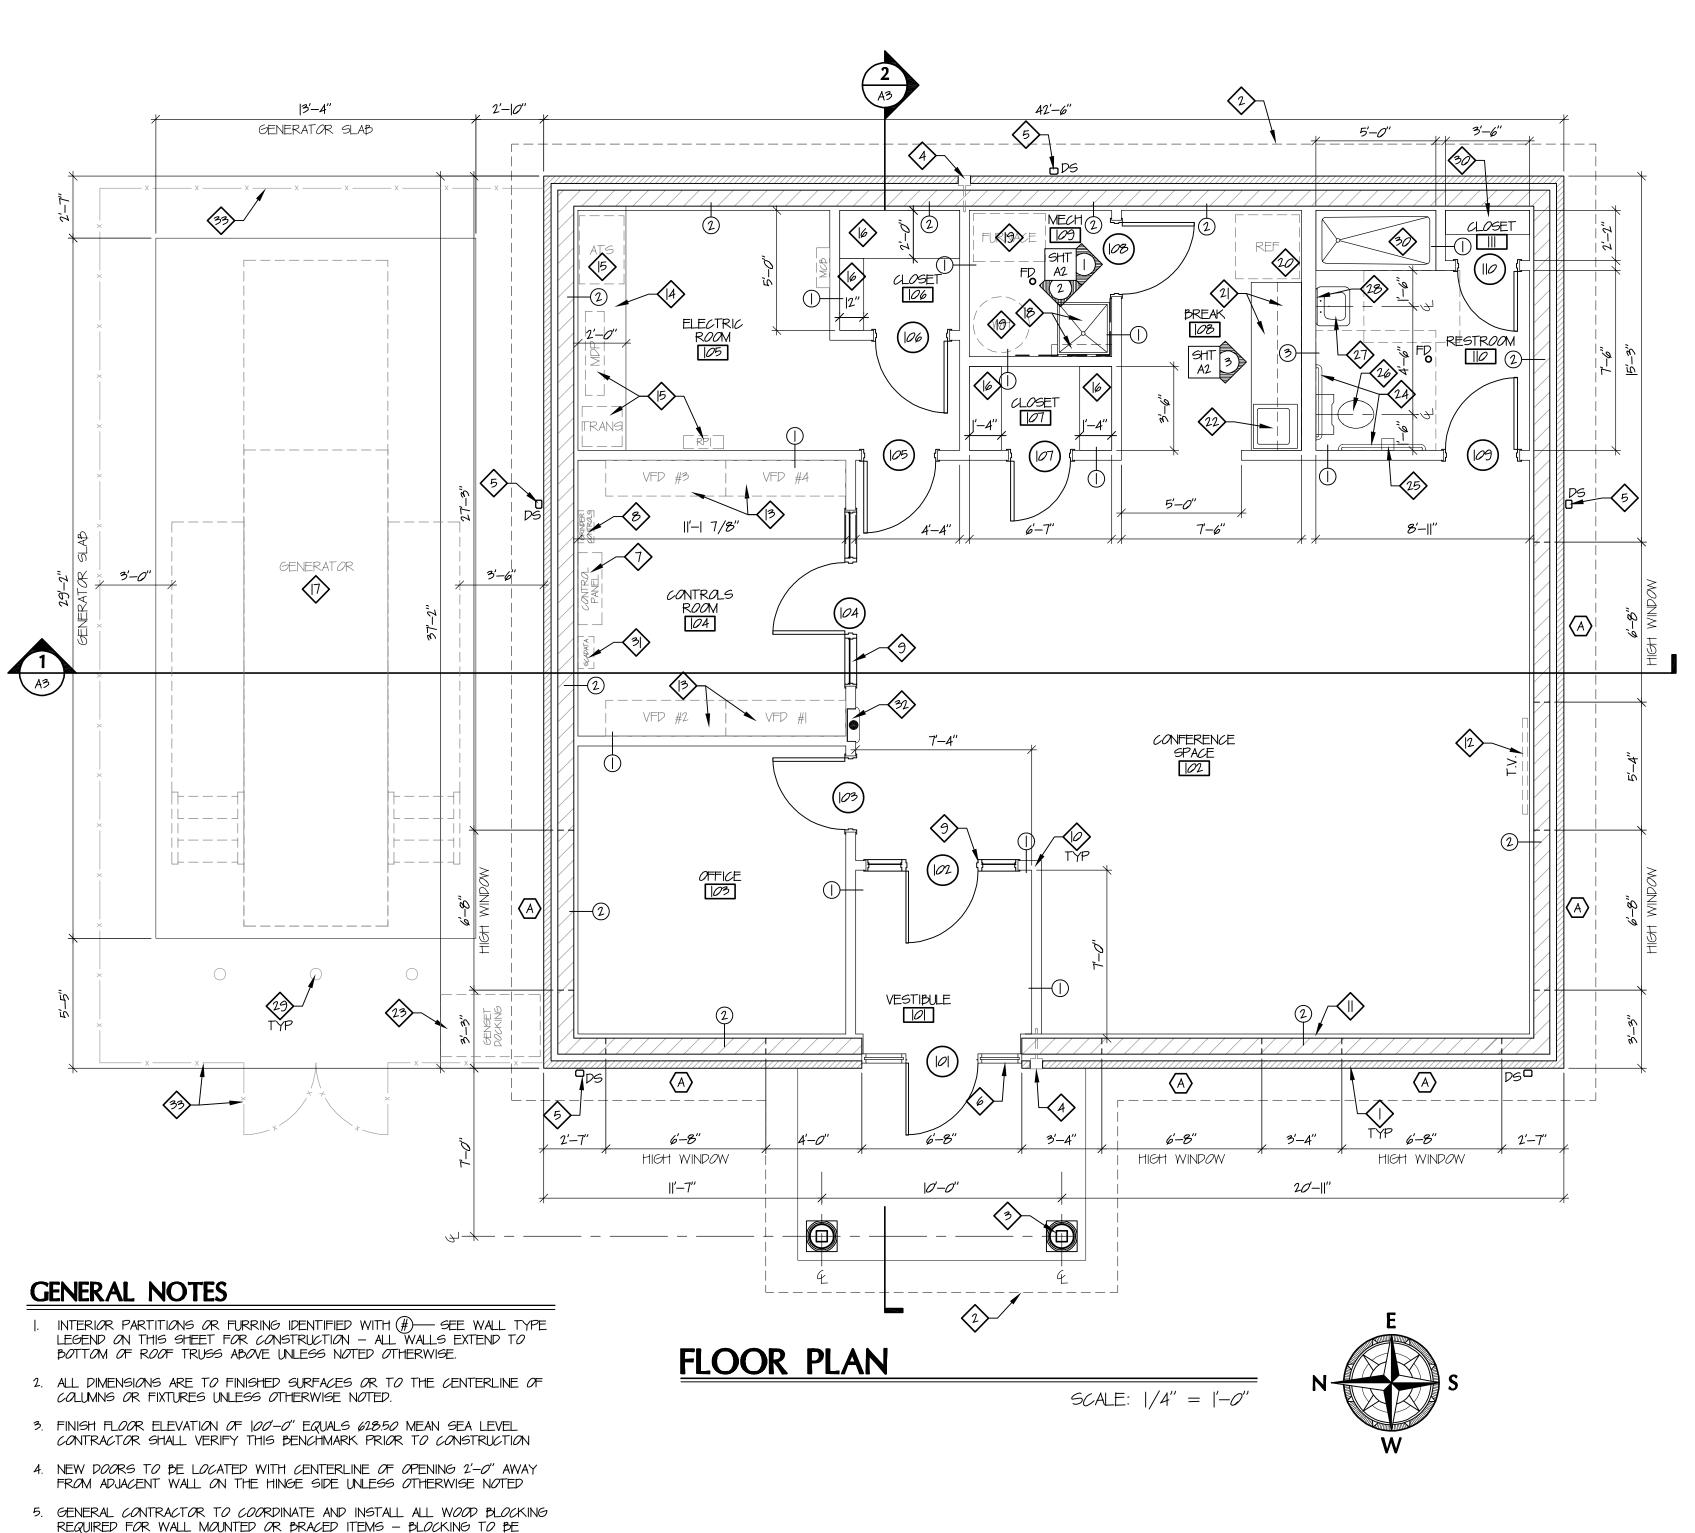
## 5/8" GYPSUM BOARD 3-5/8" 20 GA. METAL STUDS AT 24" O.C. SOUND ATTENUATION BLANKETS IN ALL STUD CAVITIES

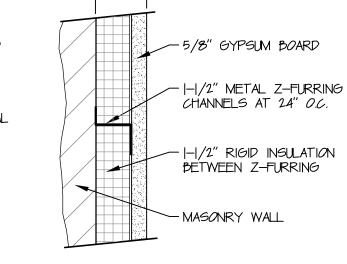

NON-RATED FURRING

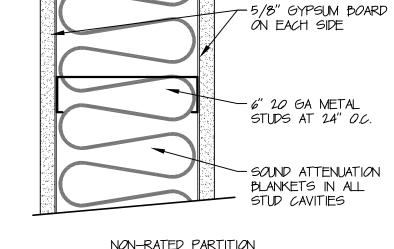

RESTROOM

NON-RATED PARTITION WALL TYPE UL. DESIGN NUMBER: N/A

 $\langle 4 \rangle$  5/8" GYPSUM BOARD CEILING AT 8'-0" A.F.F.

U.L. DESIGN NUMBER: N/A

65 GYPSUM BOARD BULKHEAD WITH BOTTOM AT 8'-O" AF.F. - MATCH WIDTH

## DRAWING NOTES - FLOOR PLAN

- \$\ightarrow\begin{array}{c} \begin{array}{c} \begin{array
- (2) LINE OF ROOF OVERHANG SEE ELEVATIONS AND ROOF PLAN
- (3) FIBERGLASS COLUMN WRAPS OVER STRUCTURAL WOOD COLUMN

SUFFICIENT THICKNESS FOR FASTENERS USED TO SECURE WALL MOUNTED

- RECESSED FROST-PROOF HOSE BIB IN LOCKABLE BOX INSTALL WITH CENTERLINE OF BOX AT 2'-O" A.F.F.
- PREFINISHED SHEET METAL DOWNSPOUT WITH CONCRETE SPLASHBLOCK AT GRADE GET GITE DRAWNSCO TOO CONTRIBUTIONS AT GRADE - SEE SITE DRAWINGS FOR CONTINUATION
- (6) ALUMINUM STOREFRONT ENTRANCE SYSTEM SEE DOOR SCHEDULE
- (1) LIFT STATION CONTROL PANEL BY OTHERS
- (8) GRINDER CONTROL PANEL BY OTHERS

OR BRACED ITEMS

- (9) HOLLOW METAL DOOR WITH BORROWED LITES PER DOOR SCHEDULE
- (10) NEW INTERIOR PARTITION SEE WALL TYPE LEGEND ON THIS SHEET
- FURRING ON INTERIOR SIDE OF EXTERIOR WALLS SEE WALL TYPE LEGEND ON THIS SHEET
- T.V. PROVIDED AND INSTALLED BY OWNER PROVIDE POWER AND DATA CONNECTIONS PER ELECTRICAL DRAWINGS COORDINATE MOUNTING HEIGHT WITH OWNER FOR BLOCKING, POWER AND DATA INSTALLATION
- (13) LIFT STATION VFD PANELS BY OTHERS
- (14) 4" HIGH CONCRETE EQUIPMENT PAD
- (15) ELECTRICAL EQUIPMENT SEE ELECTRICAL DRAWINGS
- (16) FULL WIDTH, HEAVY DUTY ADJUSTABLE SHELVING FROM FLOOR TO 6'-6" AF.F. PROVIDE (5) SHELVES WITH SHELF DEPTH AS DIMENSIONED ON PLAN

- (17) DIESEL BACKUP GENERATOR SEE ELECTRICAL DRAWINGS
- (18) MOP BASIN PROVIDE 4'-0" HIGH FRP ON SIDE AND REAR WALLS AND PROVIDE SHELF WITH MOP HOOKS ABOVE - SEE ELEVATION
- (9) GAS-FIRED FURNACE AND DOMESTIC WATER HEATER SEE MEP DRAWINGS
- REFRIGERATOR PROVIDED AND INSTALLED BY OWNER PROVIDE POWER AND WATER HOOKUPS - SEE ELEVATION
- 2) BASE AND WALL CABINETS WITH SOLID SURFACE COUNTERTOP SEE INTERIOR ELEVATION
- (22) STAINLESS STEEL SINGLE BOWL SINK SEE PLUMBING DRAWINGS
- (23) DOCKING STATION FOR MOBILE GENERATOR HOOKUP PROVIDE 4" THICK CONCRETE SLAB UNDER UNIT - SEE ELECTRICAL DRAWINGS
- PROVIDE THE FOLLOWING GRAB BARS AT THE ACCESSIBLE WATER CLOSET MOUNTED HORIZONTALLY BETWEEN 2'-9" AND 3'-0" AF.F. - 36" LONG GRAB BAR ON REAR WALL - 6" FROM SIDE WALL - 42" LONG GRAB BAR ON SIDE WALL - 12" FROM REAR WALL MOUNTED VERTICALLY WITH BOTTOM OF RAIL BETWEEN 3'-3" AND 3'-5" - 18" VERTICAL GRAB BAR ON SIDE WALL - 4'-6" FROM REAR WALL
- 26 FLOOR MOUNTED ACCESSIBLE WATER CLOSET WITH RIM AT 17" A.F.F.
- 18"  $\times$  36" MIRROR CENTERED ON LAVATORY MOUNT WITH BOTTOM OF MIRROR AT 3'-4" A.F.F. BOBRICK B-165 OR EQUAL
- SITE DRAWINGS FOR LOCATION AND BOLLARD DETAILS

- 30 30" x 60" ACRYLIC SHOWER BASE
- (31) SCADATA CONTROLS BY OTHERS
- SEMI-RECESSED CABINET WITH FIRE EXTINGUISHER MOUNTED WITH TOP OF CABINET AT 5-d' A.F.F.
- (33) CHAIN LINK FENCE WITH PAIR OF SWINGING GATES SEE SITE DRAWINGS

## NON-RATED PARTITION WALL TYPE WALL TYPE

U.L. DESIGN NUMBER: N/A

Sheet Title

FLOOR PLAN AND **CEILING PLAN** 

> 06308.12 Project Number AS NOTED Drawing Scale **Sheet Number**

CITY TREE

File Number

SIO SE

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■ Engineering

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CSW

NONE

06308121-4L1

No. Date

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REFLECTED CEILING PLAN SCALE: |/4'' = |'-0''8 RECESSED CAN LIGHT - SEE ELECTRICAL DRAWINGS


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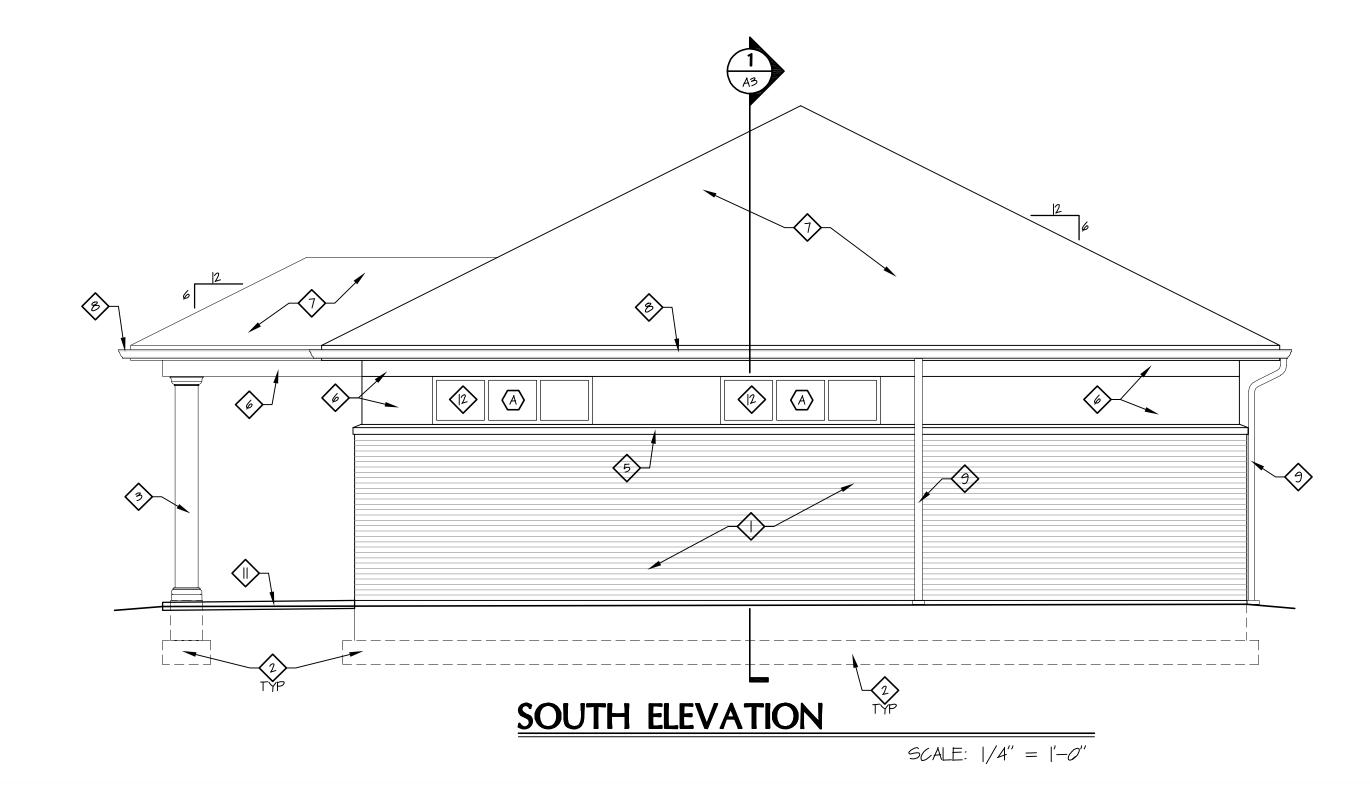
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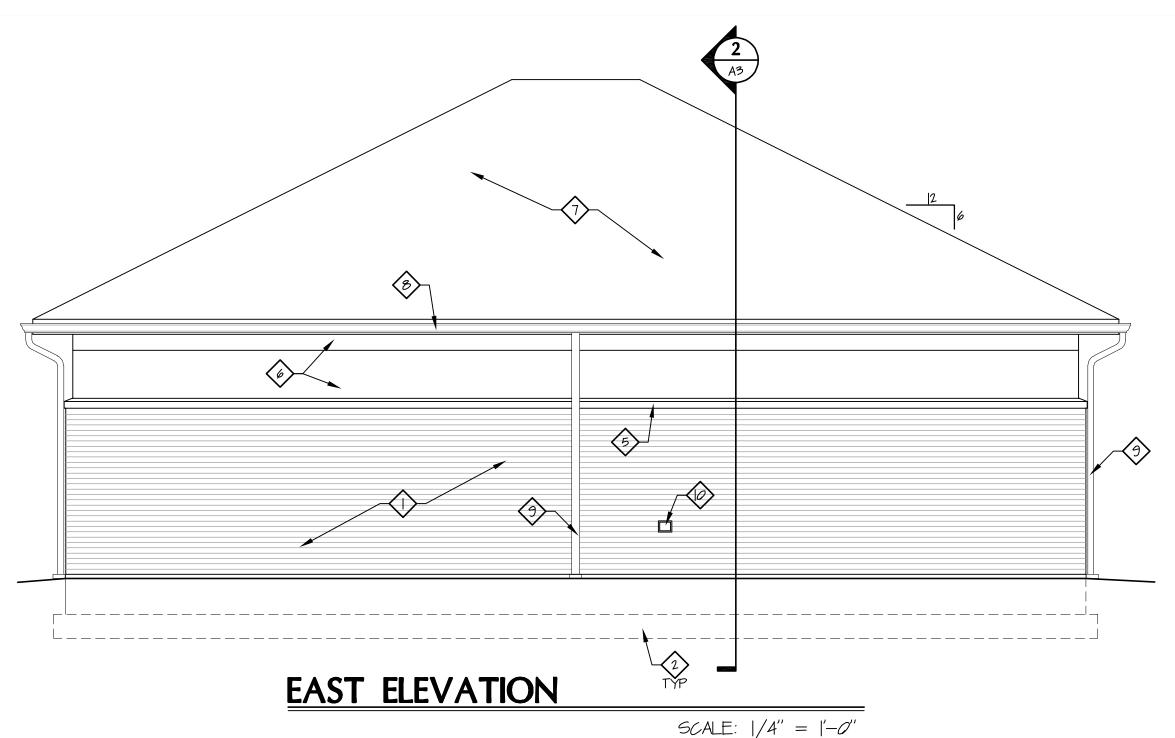
(25) TOILET PAPER DISPENSER


(27) WALL HUNG ACCESSIBLE LAVATORY MOUNTED WITH RIM AT 2'-10" A.F.F. MAX

6" DIA CONCRETE-FILLED STEEL PIPE BALLARD - MIN 36" HIGH - SEE





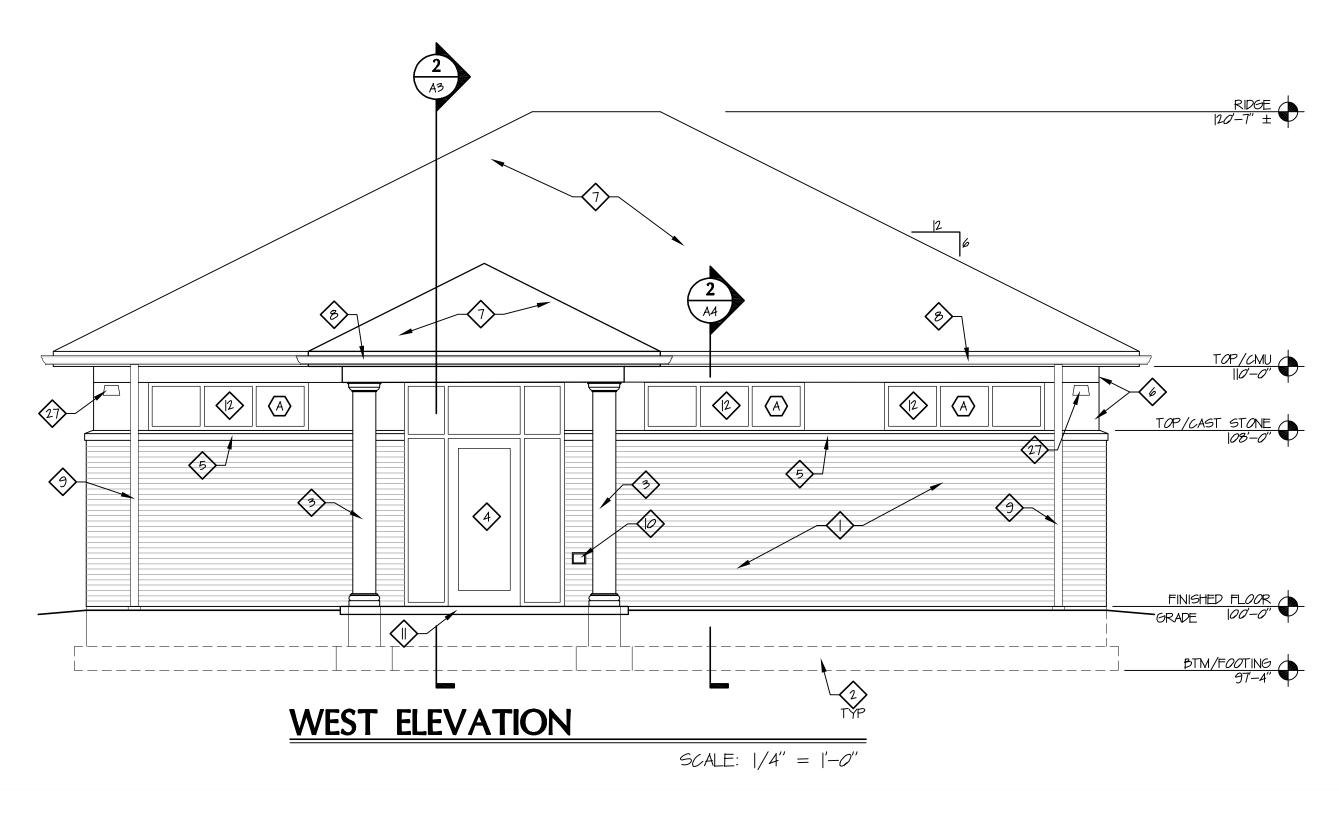


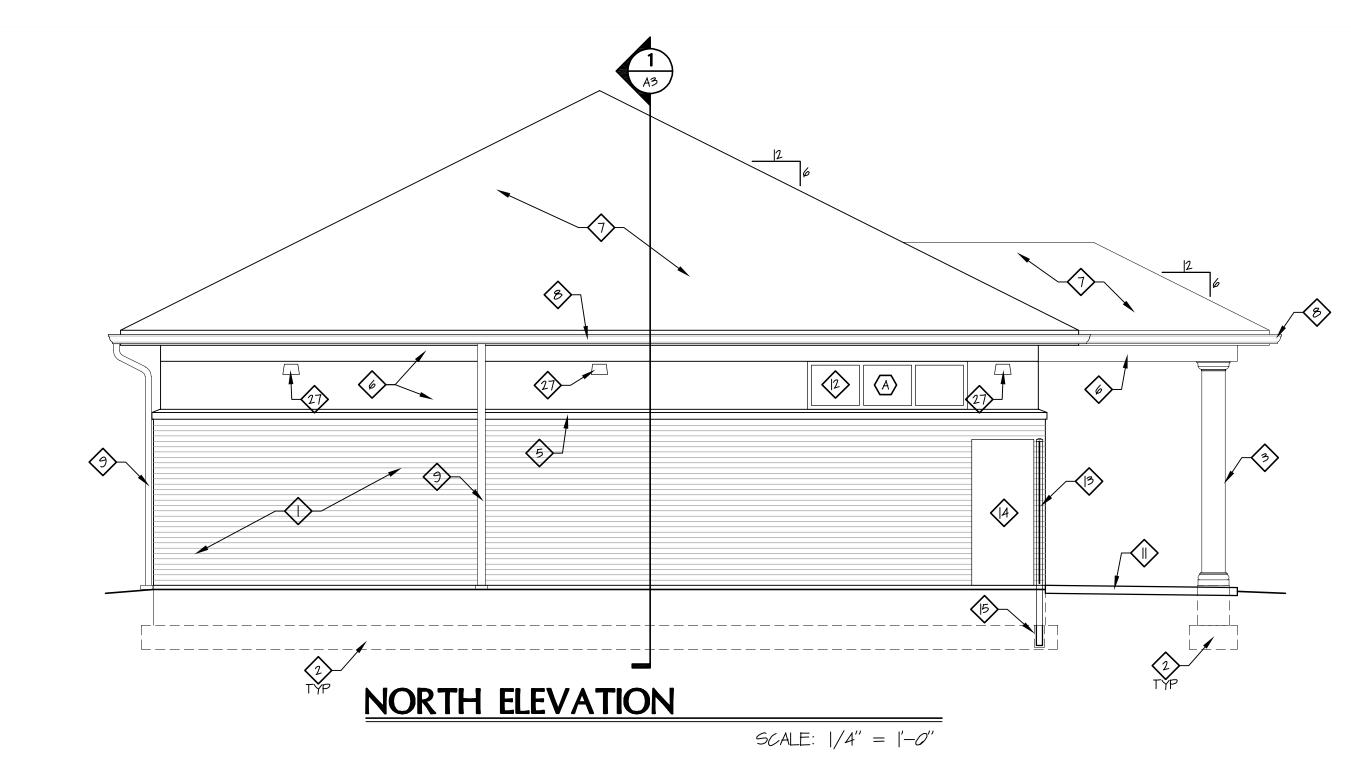


## DRAWING NOTES

- \$\ightarrow\text{prick Veneer cavity wall see building and wall sections
- (2) CONCRETE FOUNDATIONS SEE STRUCTURAL DRAWINGS
- (3) FIBERGLASS COLUMN PAINTED
- 4) ALUMINUM STOREFRONT ENTRANCE SYSTEM WITH SIDE AND TRANSOM LITES SEE DOOR SCHEDULE
- (5) CAST STONE BAND PROFILE A SEE WALL SECTION
- (6) EXTERIOR INSULATION AND FINISH SYSTEM SEE WALL SECTIONS
- (7) ASPHALT SHINGLE ROOF
- 8 PREFINISHED SHEET METAL GUTTER
- PREFINISHED SHEET METAL DOWNSPOUT DISCHARGING TO CONCRETE SPLASH BLOCK AT GRADE DOWNSPOUTS TO BE 3" x 4" SMOOTH
- FROST-PROOF HOSE BIB IN RECESSED LOCKABLE WALL BOX INSTALLED WITH CENTERLINE OF BOX AT 1'-O" A.F.F. SEE MEP DRAWINGS
- (II) 4" CONCRETE SLAB ON GRADE
- (12) FIXED ALUMINUM STOREFRONT WINDOW 6'-8'' WIDE x 2'-0'' HIGH
- (13) 6'-0" HIGH CHAIN LINK FENCE SEE SITE PLAN
- (14) PORTABLE GENERATOR DOCKING STATION SEE ELECTRICAL DRAWINGS
- PROVIDE SLEEVE IN FOOTING TO ALLOW INSTALLATION OF FENCE POST ADJACENT TO FACE OF BUILDING

- SERVICE SINK SEE MEP DRAWINGS
- (17) SOAP DISPENSER MOUNTED ON WALL WITH DISPENSER AT 4'-O" A.F.F.
- (18) PAPER TOWEL DISPENSER MOUNTED SO TOWELS DISPENSE AT 4'-0" A.F.F.
- INSTALL FRP PANELING TO 4'-0" A.F.F. ON WALLS BEHIND MOP SINK FRP PANELING TO EXTEND 48" TO NORTH AND TERMINATE AT DOOR FRAME
- 20 MOP RACK WITH SHELF MOUNT WITH SHELF AT 5'-0" A.F.F.
- 2) OWNER PROVIDED REFRIGERATOR PROVIDE ELECTRIC OUTLET AT 48" AFF. AND RECESSED WATER VALVE BOX AT 18" AFF.
- WALL CABINET WITH (2) ADJUSTABLE SHELVES
- (23) BASE CABINET WITH ADJUSTABLE SHELF
- (24) SINK BASE CABINET
- (25) SOLID SURFACE COUNTERTOP WITH 4" HIGH BACK AND SIDE SPLASH
- (26) ELECTRICAL OUTLET FOR MICROWAVE
- (27) LIGHT WALL PACK SEE ELECTRICAL DRAWINGS

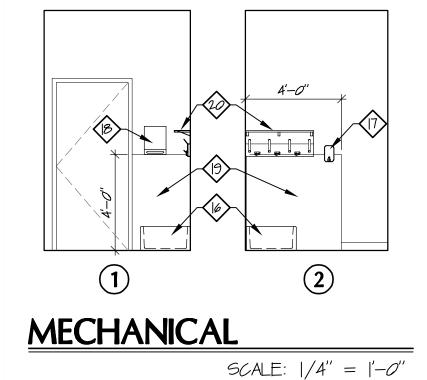

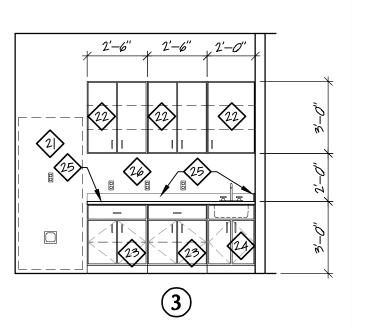

BREAK ROOM

SCALE: 1/4'' = 1'-0''

■ Engineering ■ Landscape Architecture Cincinnati OH 45241 Planning ■ Surveying Project Manager CSW Drawn By 06308121-4Q1 NONE

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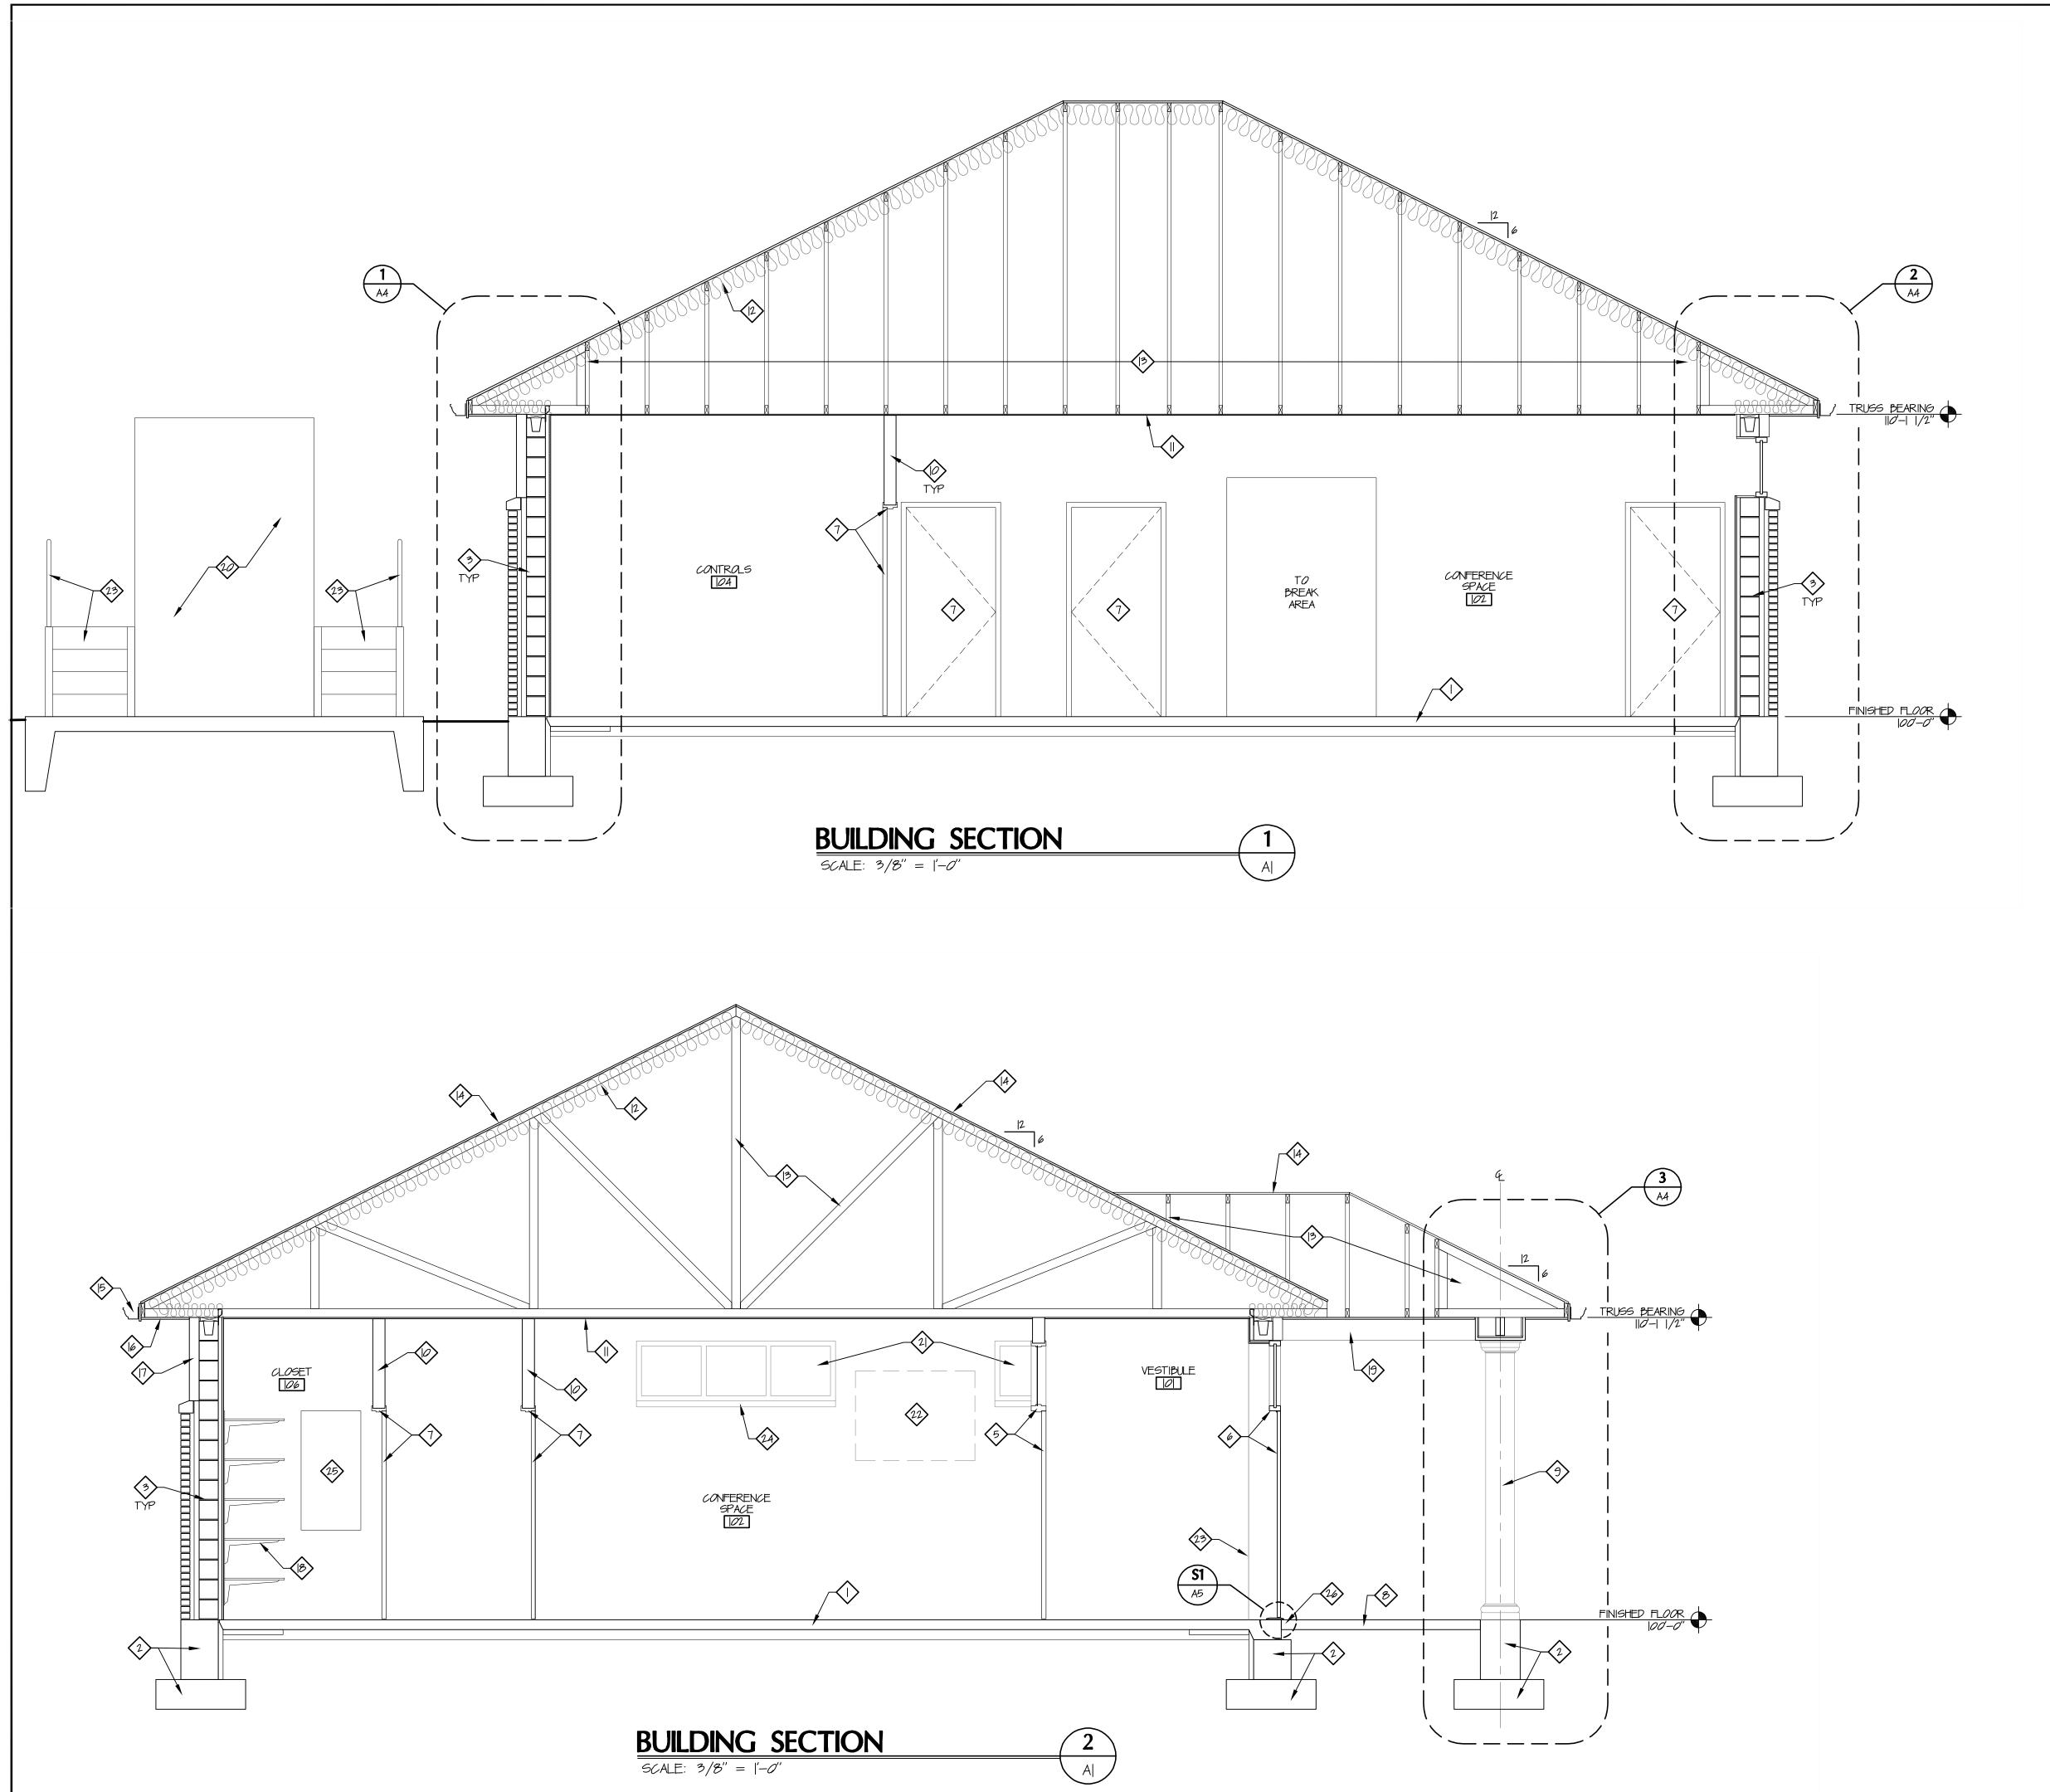
Sheet Title

**BUILDING ELEVATIONS** 

06308.12 Project Number Drawing Scale **Sheet Number** File Number

AS NOTED

CITY TREE



## DRAWING NOTES

4" CONCRETE SLAB OVER VAPOR BARRIER OVER 4" COMPACTED GRANULAR BASE OVER COMPACTED SUBGRADE — SEE STRUCTURAL

(2) CONCRETE FOUNDATIONS - SEE STRUCTURAL DRAWINGS

(3) BRICK VENEER CAVITY WALL - SEE WALL SECTIONS

(4) NOT USED

5 HOLLOW METAL DOOR FRAME WITH BORROWED LITES AND TRANSOM LITE SEE DOOR SCHEDULE

(6) ALUMINUM STOREFRONT ENTRANCE SYSTEM - SEE DOOR SCHEDULE

(7) HALLOW METAL DOOR & FRAME - SEE DOOR SCHEDULE

4" CONCRETE SLAB ON GRADE SLOPED AWAY FROM BUILDING ENTRANCE SEE SITE PLAN FOR SLAB ELEVATIONS

(9) FIBERGLASS PORCH COLUMN BEYOND

PARTITIONS EXTEND TO FINISHED CEILING - SEE WALL TYPE LEGEND

(11) 5/8" GYPSUM BOARD CEILING APPLIED TO BOTTOM CHORD OF TRUSSES

R-30 BATT INSULATION IN ALL VOIDS BETWEEN ROOF TRUSSES AT TOP CHORD OF TRUSS

(3) ENGINEERED WOOD ROOF TRUSSES AT 24" O.C.

ASPHALT SHINGLES OVER DOUBLE LAYER OF 15# FELT OVER 15/32" EXTERIOR GRADE PLYWOOD SHEATHING

PREFINISHED 5" K-STYLE SHEET METAL GUTTER

PREFINISHED SHEET METAL SOFFIT MATERIAL FASTENED TO BOTTOM OF ROOF TRUSSES AND WOOD BLOCKING AS REQUIRED

(17) E.I.F.S. - SEE BUILDING ELEVATIONS AND WALL SECTIONS

(B) ADJUSTABLE SHELVING - SEE FLOOR PLAN

(19) E.I.F.S. BULKHEAD AT PORCH - SEE REFLECTED CEILING PLAN

 $\langle 2 \rangle$  BACKUP GENERATOR - SEE M/E/P DRAWINGS

 $\langle 21 \rangle$  WINDOW BEYOND - SEE ELEVATIONS AND WINDOW SCHEDULE

722 T.V. BY OWNER - PROVIDE POWER, DATA AND WOOD BLOCKING IN WALL COORDINATE FINAL LOCATION OF T.V WITH OWNER

53 SERVICE PLATFORM AND STAIRS BY GENERATOR MANUFACTURER

(24) SOLID SURFACE WINDOW SILL AND APRON

PROVIDE 3/4" THICK PLYWOOD PANEL FOR MOUNTING ACCESS CONTROL HARDWARE  $-24^{\prime\prime}$  x 48 MOUNTED WITH TOP OF PANEL AT 7-0 AFF. WITH SCREWS AND FINISH WASHERS - PAINT PANEL TO MATCH WALL

SEE STRUCTURAL DRAWINGS FOR JUNCTURE OF FLOOR SLAB AND PORCH SLAB / SIDEWALK

McGill Smith Punshon

Planning

■ Surveying

Architecture 3700 Park 42 Drive Engineering Suite 190B ■ Landscape Architecture Cincinnati OH 45241 Phone 513.759.0004 www.mspdesign.com

Project Manager CSW Drawn By 06308121-4S1 NONE X-Ref(s)

Issue/Revision No. Date **BID/PERMIT** 08/15/25

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Exp. Date 12/31/25 SIO

CITY STREE1


Sheet Title

**BUILDING SECTIONS** 

**PUBLIC** 

Project Number Drawing Scale Sheet Number

06308.12 AS NOTED A3

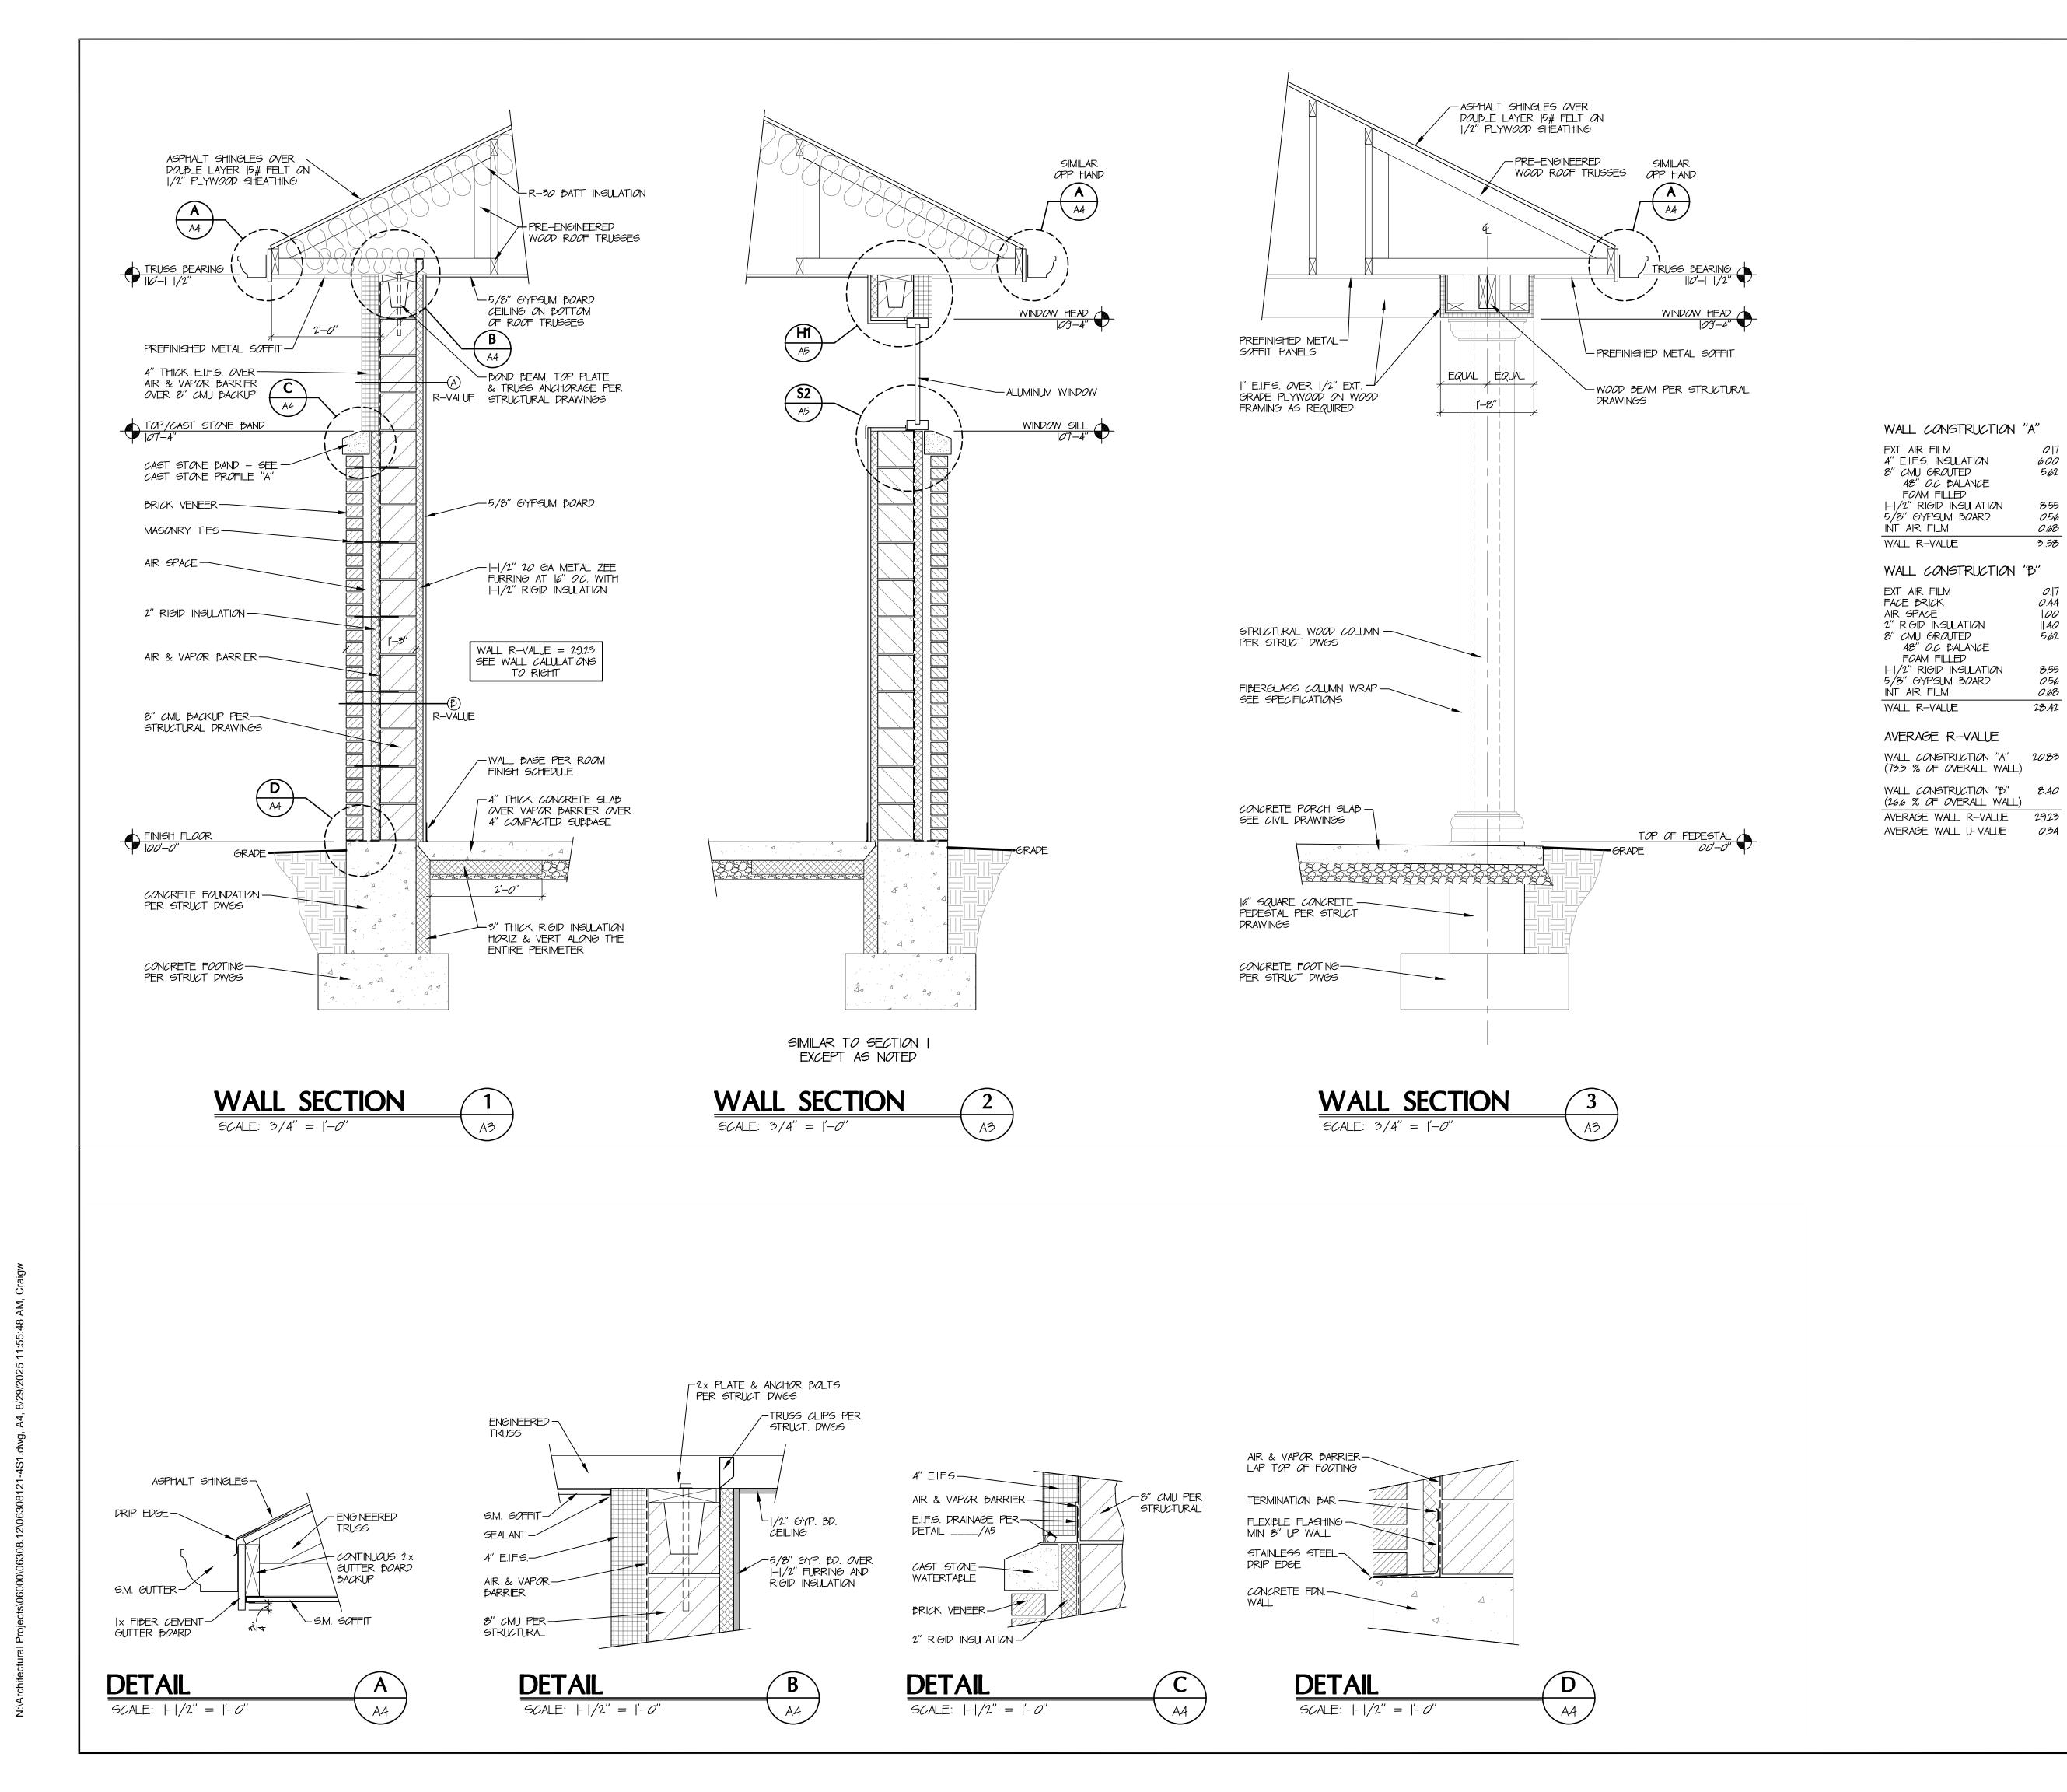



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No. Date

RDN Project Manager CSW Drawn By 06308121-4S1 DWG NONE X-Ref(s)

Issue/Revision

16.00 5.62

8.55

0.56

0.68

3|.58

0.|7 0.44

|.00 ||.40

5.62

8.55

0.56

0.68

28.42

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SION SE CITY STREE **PUBLIC** 

Sheet Title

WALL SECTIONS

06308.12 Project Number Drawing Scale Sheet Number File Number

AS NOTED A4

397

				OORS	C F	HEDULE						
DOOR	HARDWARE		D 0 0 R	FRAME DA1	ΓА	DE	TAI	LS	FIRE	NOTEC		
NUM	SET #	AMT	DOOR SIZE	MATERIAL	ELEV.	MATERIAL	ELEV.	HEAD	JAMB	SILL	RATING	NOTES
101	1	1	3'-0" x 7'-0"	ALUMINUM	А	A ALUMINUM		H1	J1	S1	N/A	1
102	2	1	3'-0" x 7'-0" x 1-3/4"	HOLLOW METAL	А	HOLLOW METAL	А	H2	J2	N/A	N/A	
103	2	1	3'-0" x 7'-0" x 1-3/4"	HOLLOW METAL	В	HOLLOW METAL	В	H2	J2	N/A	N/A	
104	2	1	3'-0" x 7'-0" x 1-3/4"	HOLLOW METAL	С	HOLLOW METAL	С	H2	J2	N/A	N/A	
105	3	1	3'-0" x 7'-0" x 1-3/4"	HOLLOW METAL	В	HOLLOW METAL	В	H2	J2	N/A	N/A	
106	4	1	3'-0" x 7'-0" x 1-3/4"	HOLLOW METAL	В	HOLLOW METAL	В	H2	J2	N/A	N/A	
107	4	1	2'-6" x 7'-0" x 1-3/4"	HOLLOW METAL	В	HOLLOW METAL	В	H2	J2	N/A	N/A	
108	4	1	3'-0" x 7'-0" x 1-3/4"	HOLLOW METAL	В	HOLLOW METAL	В	H2	J2	N/A	N/A	
109	5	1	3'-0" x 7'-0" x 1-3/4"	HOLLOW METAL	В	HOLLOW METAL	В	H2	J2	N/A	N/A	
110	4	1	2'-6" x 7'-0" x 1-3/4"	HOLLOW METAL	В	HOLLOW METAL	В	H2	J2	N/A	N/A	

## DOOR HARDWARE SETS

HARDWARE SET #1

CONTINUOUS ALUMINUM HINGE OFFICE FUNCTION LOCK AND CORE

ELECTRIC STRIKE PROXIMITY CARD READER FRAME WIRING HARNESS

**CLOSER** WEATHER STRIPPING / GASKETING DOOR SWEEP

ACCESSIBLE THRESHOLD

HARDWARE SET #2

(3) 4.5 x 4.5 HINGES OFFICE FUNCTION LOCK WITH LEVER HANDLES SET OF SILENCERS

HARDWARE SET #3

(3) 4.5 x 4.5 HINGES

STOREROOM FUNCTION LOCK WITH LEVER HANDLES CL0SER

SET OF SILENCERS

HARDWARE SET #4


(3) 4.5 x 4.5 HINGES STOREROOM FUNCTION LOCK WITH LEVER HANDLES SET OF SILENCERS

HARDWARE SET #5

(3) 4.5 x 4.5 HINGES PRIVACY FUNCTION LOCK WITH OCCUPANCY INDICATOR


(EGRESS PERMITTED AT ALL TIMES) LEVER HANDLES

EMERGENCY OVERRIDE KEY SET OF SILENCERS

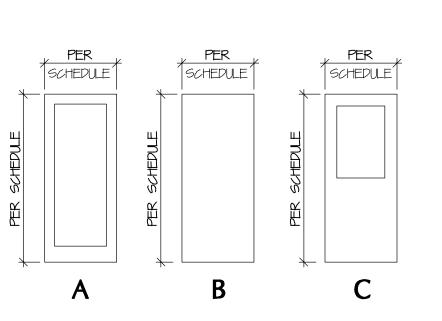

## DOOR ELEVATIONS

SCALE: 1/4'' = 1'-0''

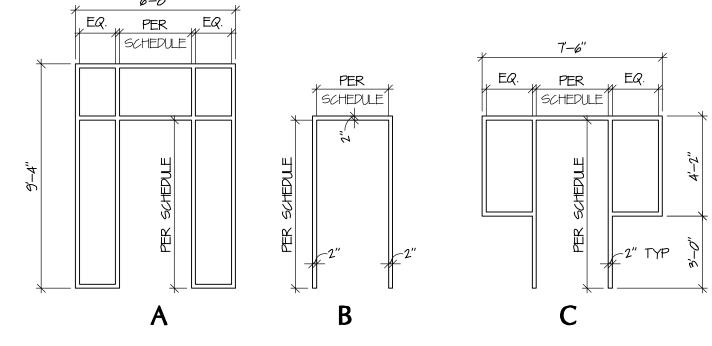



## DOOR FRAME ELEVATIONS


-5/8" GYPSUM BOARD OVER 1-1/2" ZEE FURRING WITH RIGID INSULATION

- RETURN BRICK TO CMU BACKUP


SCALE: 1/4'' = 1'-0''

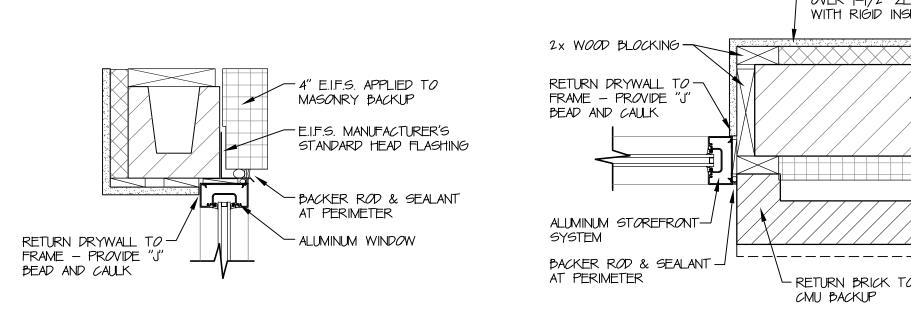

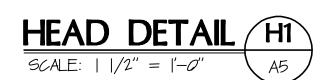


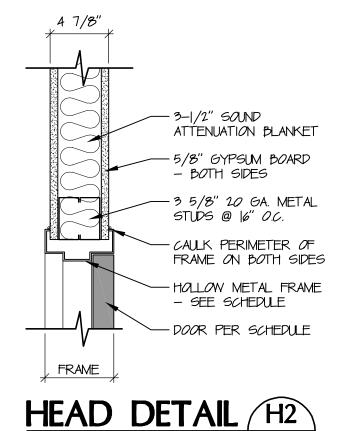


SCALE: | |/2'' = |'-0''|

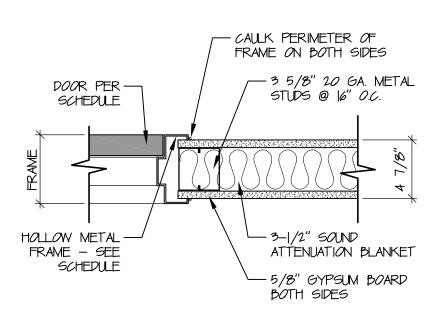

JAMB DETAIL (J1

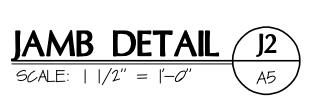

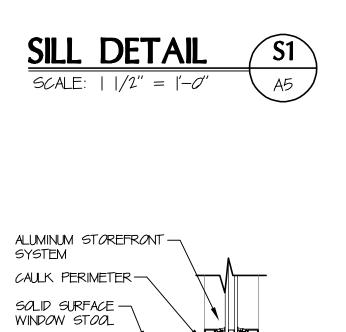

- ALUMINUM STØREFRØNT

- ACCESSIBLE THRESHOLD SET IN BED OF SEALANT

SEE STRUCTURAL DRAWINGS FOR JUNCTURE OF SLABS

PORCH SLAB

SILL	DETAIL	S2
SCALE:	/2" =  '-0"	A5

	ROOM	F	INI	SH	SC	H E D	ULE	<del>-</del> -		
ROOM NUMBER	ROOM DESIGNATION	CEILI HEIGHT	NGS TYPE	NORTH	W A L EAST	L S SOUTH	FLOOR	BASE	NOTES	
101	VESTIBULE	10'-0"	C-1	W-1	W-1	W-1	WEST W-1	F-1	B-1	1
102	CONFERENCE SPACE	10'-0"	C-1	W-1	W-1	W-1	W-1	F-1	B-1	1 & 2
103	OFFICE	10'-0"	C-1	W-1	W-1	W-1	W-1	F-2	B-1	1
104	CONTROLS ROOM	10'-0"	C-1	W-2	W-1	W-1	W-1	F-1	B-1	1
105	ELECTRIC ROOM	10'-0"	C-1	W-2	W-2	W-1	W-1	F-3	B-1	1 & 3
106	CLOSET	10'-0"	C-1	W-1	W-2	W-1	W-1	F-1	B-1	1
107	CLOSET	10'-0"	C-1	W-1	W-1	W-1	W-1	F-1	B-1	1
108	BREAK AREA	10'-0"	C-1	W-1	W-1	W-1	W-1	F-1	B-1	1 & 2
109	MECHANICAL	10'-0"	C-1	W-1	W-2	W-1	W-1	F-3	B-1	1
110	RESTROOM	10'-0"	C-1	W-1/W-3	W-1/W-3	W-1	W-1/W-3	F-1	B-2	1, 4 & 5
111	CLOSET	10'-0"	C-1	W-1	W-1	W-1	W-1	F-1	B-1	1

## MATERIALS LEGEND

CEILINGS	5			
C-1	PAINTED	GYPSUM	BOARD	
C-2				
WALLS				
W-1	PAINTED	GYPSUM	BOARD	

W-2 PAINTED MASONRY W-3 CERAMIC TILE

**FLOORS** F-1 PORCELAIN TILE F-2 CARPET TILE F-3 SEALED CONCRETE

BASE

B-1 RUBBER

B-2 PORCELAIN TILE

## EQ. EQ.

## WINDOW ELEVATIONS

SCALE: |/4'' = |'-0''|

	WINDOW SCHEDULE											
MARK	WIDTH	HEIGHT	TOP OF FRAME	TYPE OF GLASS								
A	6'-8"	2'-0"	109'-4"	I" INSULATED								

## **ROOM FINISH NOTES**

- |. HOLLOW METAL DOORS & DOOR & WINDOW FRAMES TO BE PAINTED
- 2. GYPSUM BOARD BULKHEADS OR SOFFITS TO BE PAINTED TO MATCH WALLS
- 3. RUBBER BASE TO BE INSTALLED ON GYPSUM BOARD WALLS ONLY
- 4. PROVIDE CERAMIC WALL TILE FULL HEIGHT ON ALL SHOWER SURROUND WALLS
- 5. PROVIDE CERAMIC WALL TILE FROM BASE TO 6'-O" A.F.F. WITH PAINTED GYPSUM BOARD ABOVE PER INTERIOR ELEVATIONS

RDN Project Manager CSW Drawn By 06308121-4T1 NONE X-Ref(s) Issue/Revision No. Date **BID/PERMIT** 08/15/25

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■ Landscape Architecture Cincinnati OH 45241

3700 Park 42 Drive

Phone 513.759.0004

www.mspdesign.com

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CITY STREE

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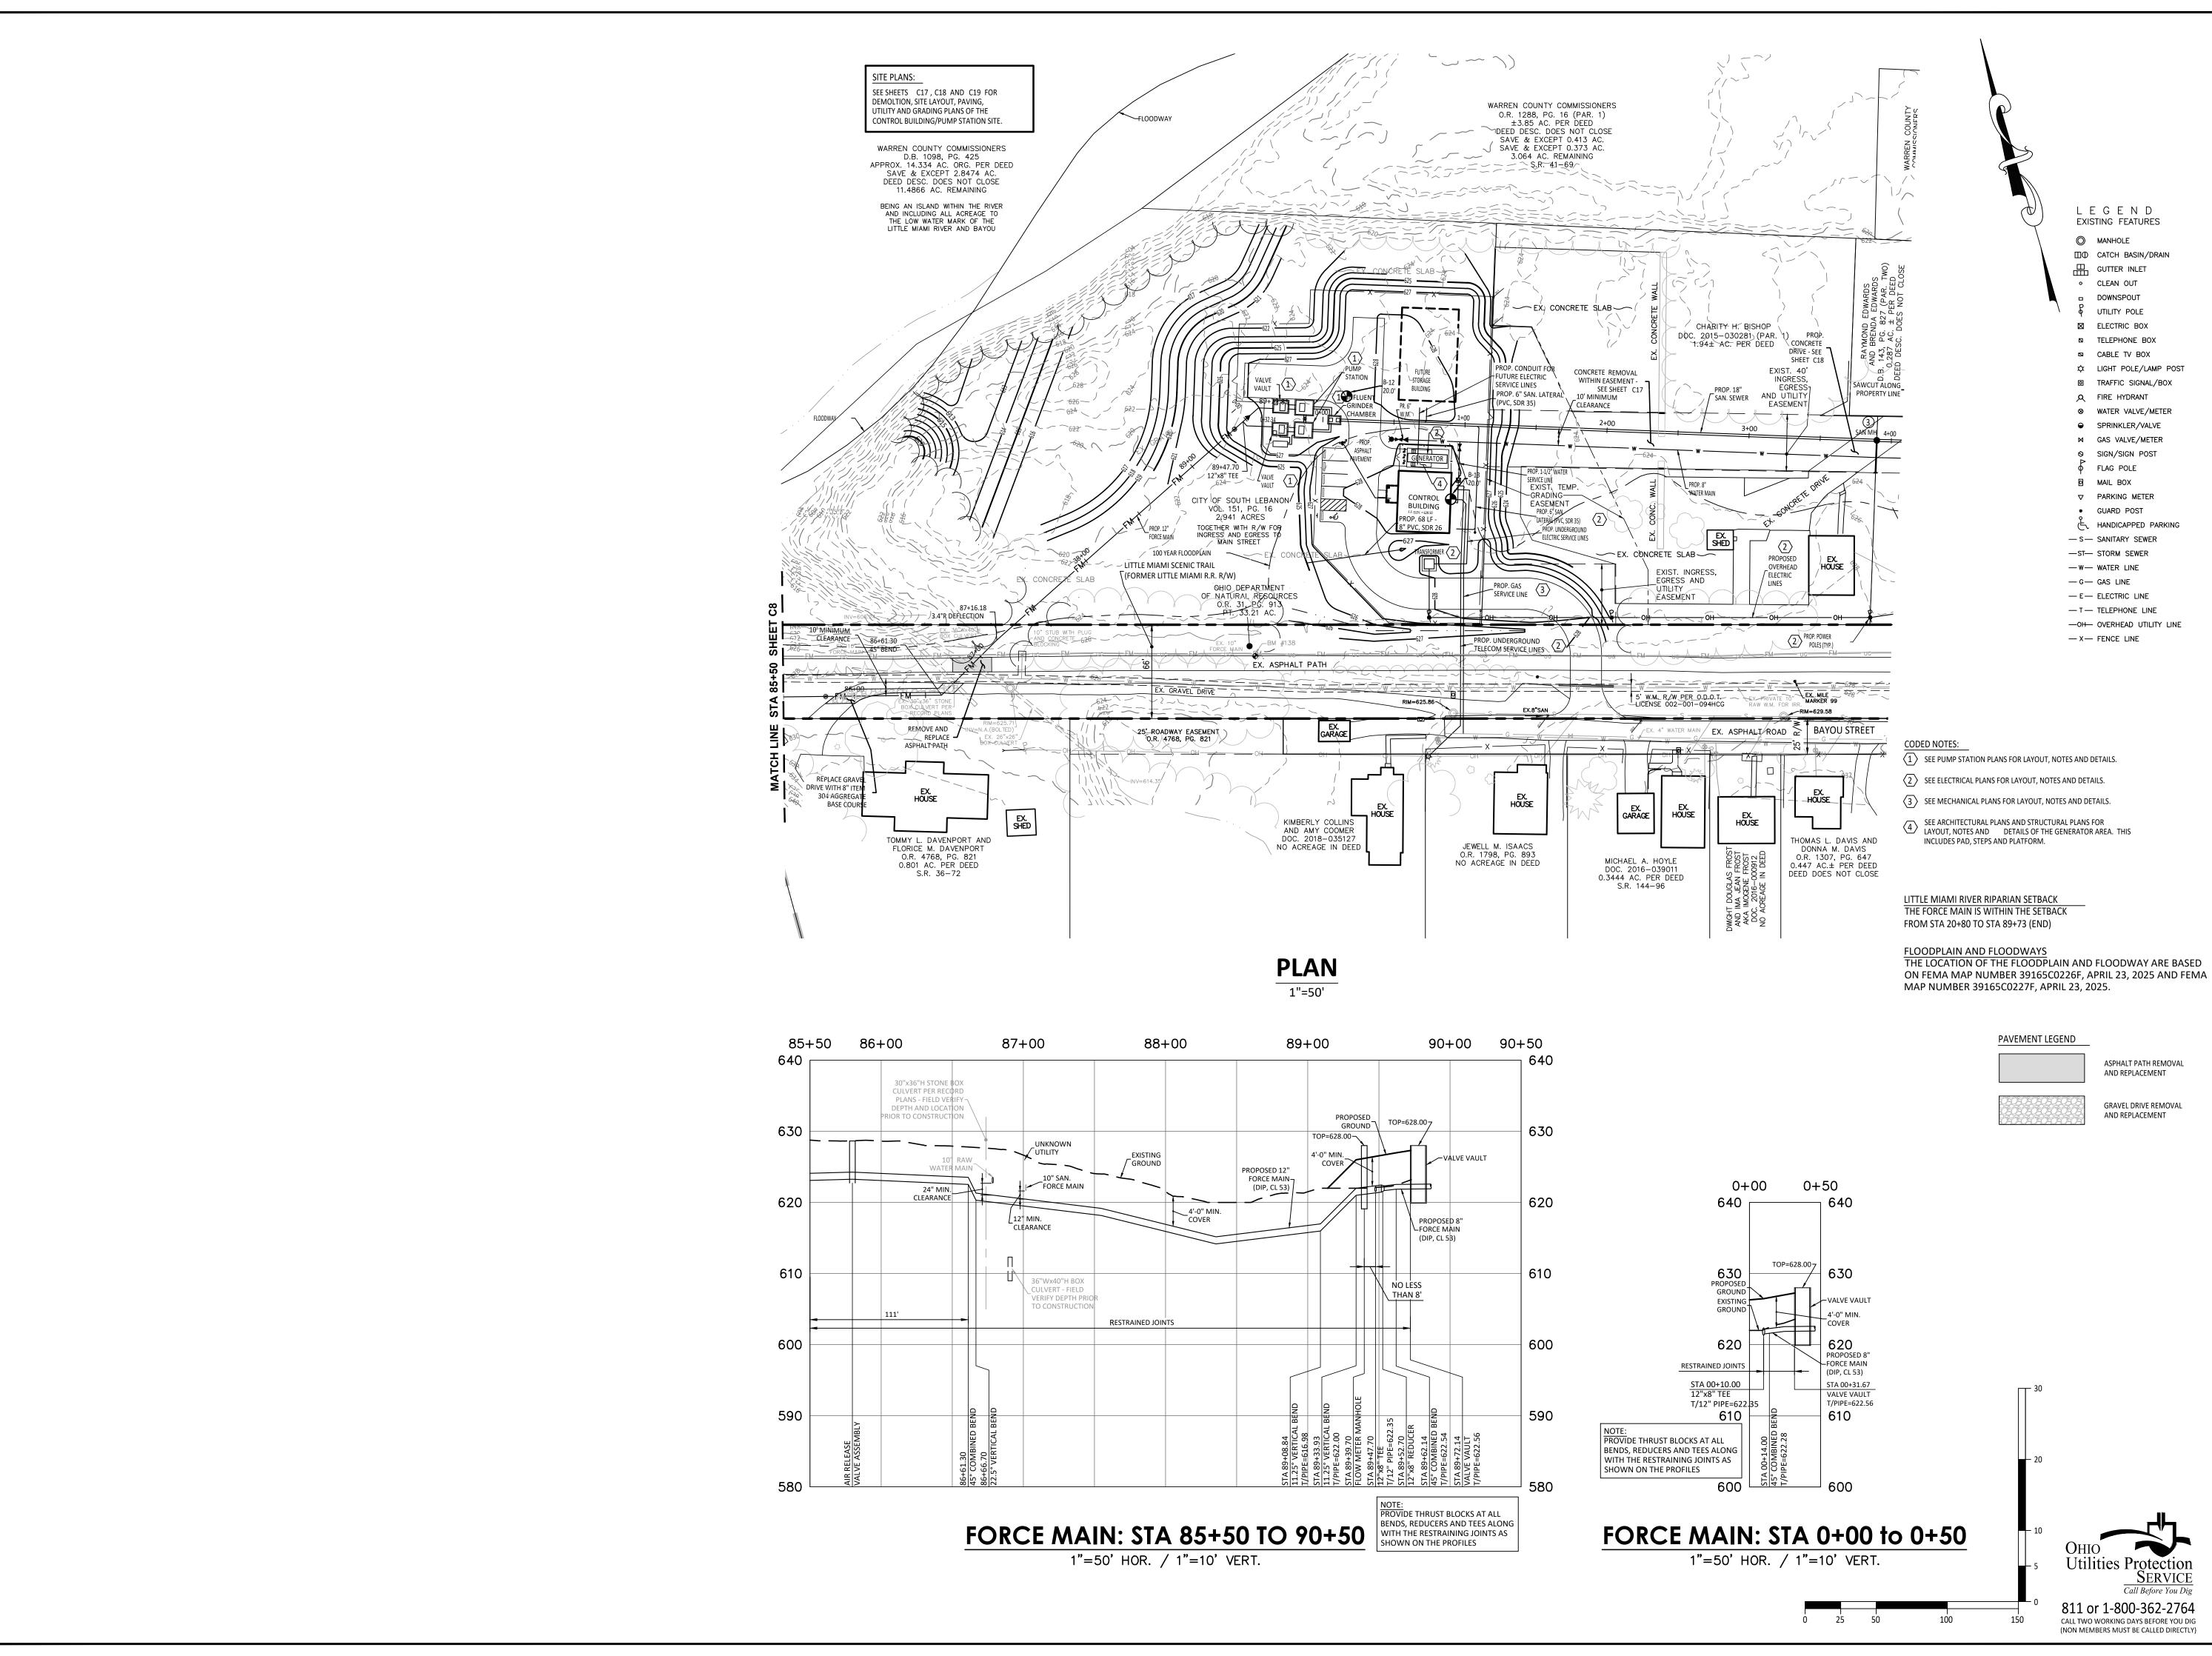
Sheet Title INTERIOR ELEVATIONS, SCHEDULES & DETAILS

**UBLIC** 

Project Number **Drawing Scale** Sheet Number

AS NOTED **A**5 File Number

06308.12





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ANDREW J DODDS E-82951 08/28/2025

## SANON

Sheet Title

## **FORCE MAIN PLAN & PROFILE**

06308.12


1" = 50'

Project Number Drawing Scale Sheet Number

File Number

**UBLIC** 

06308

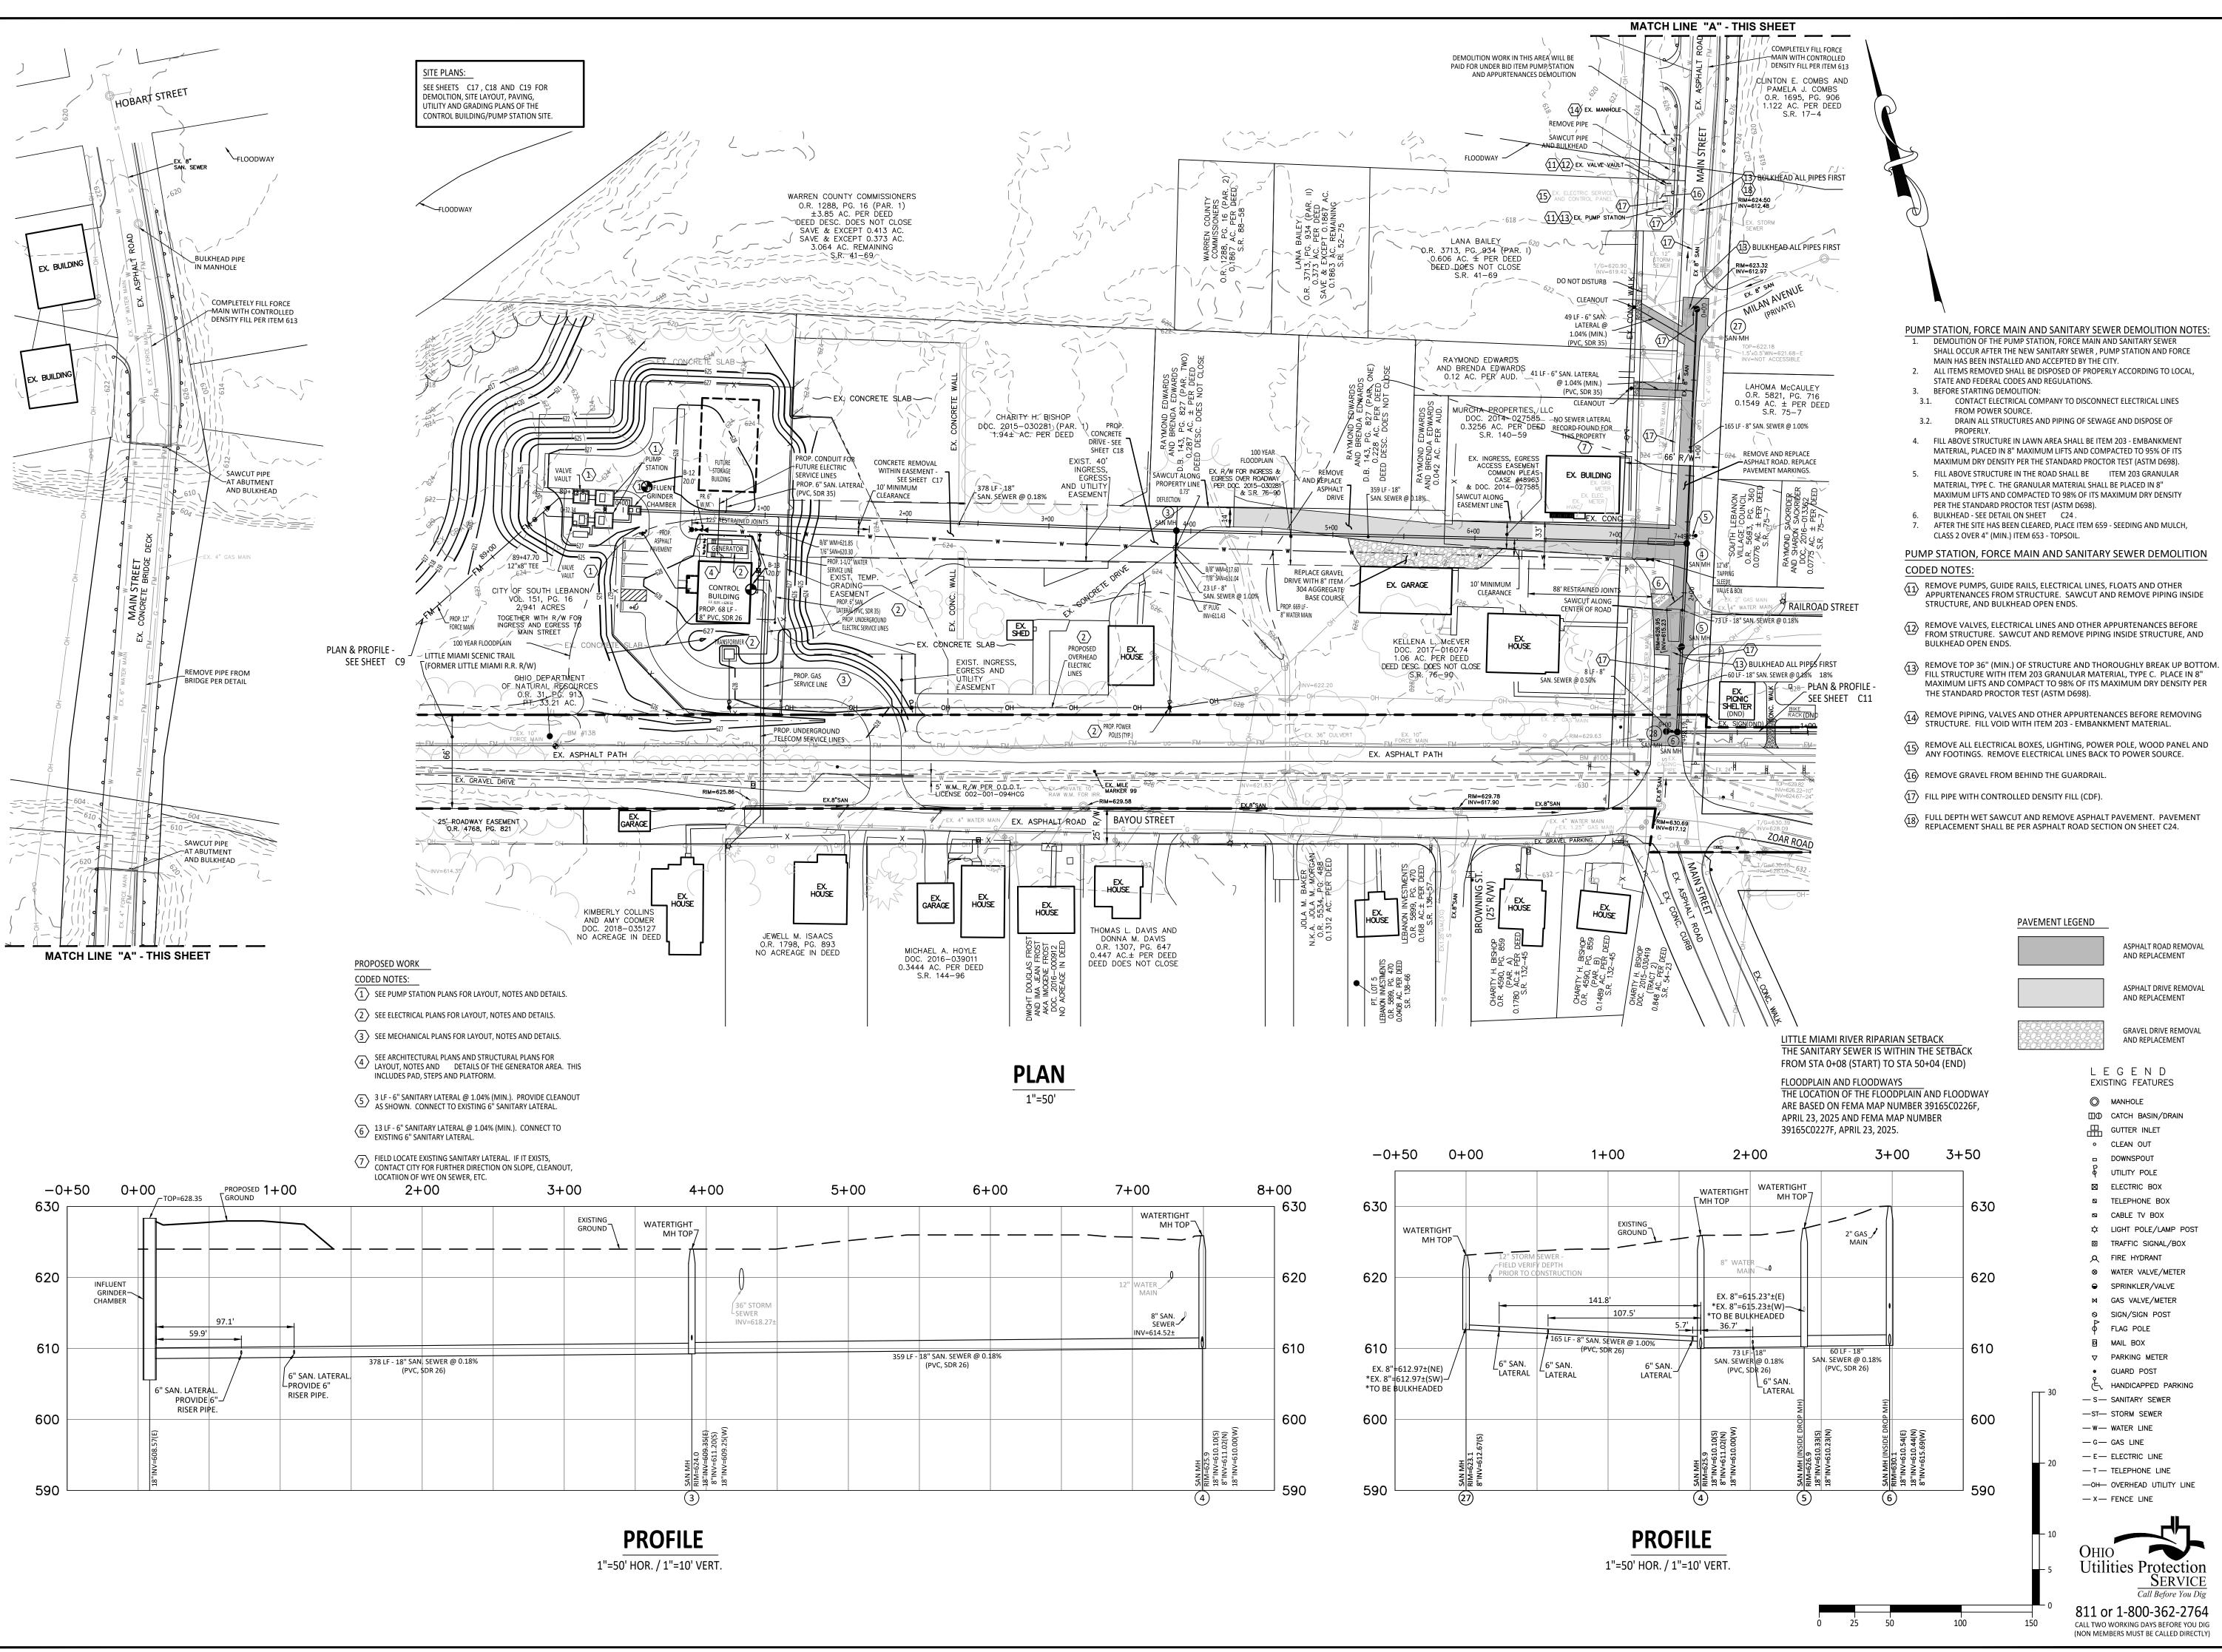


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Sheet Title


**SANITARY SEWER PLAN & PROFILE** 

06308.12 Project Number 1" = 50' Drawing Scale C10 **Sheet Number** 

06308

File Number
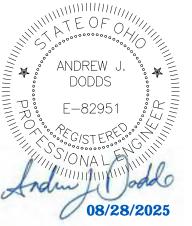
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ISSUE/Revision No. Date
PTI SUBMITTAL 10/18/22
CONCRETE DEMOLITION 02/09/22
CONCRETE DEMOLITION 02/21/22
BID/PERMIT 8/15/25
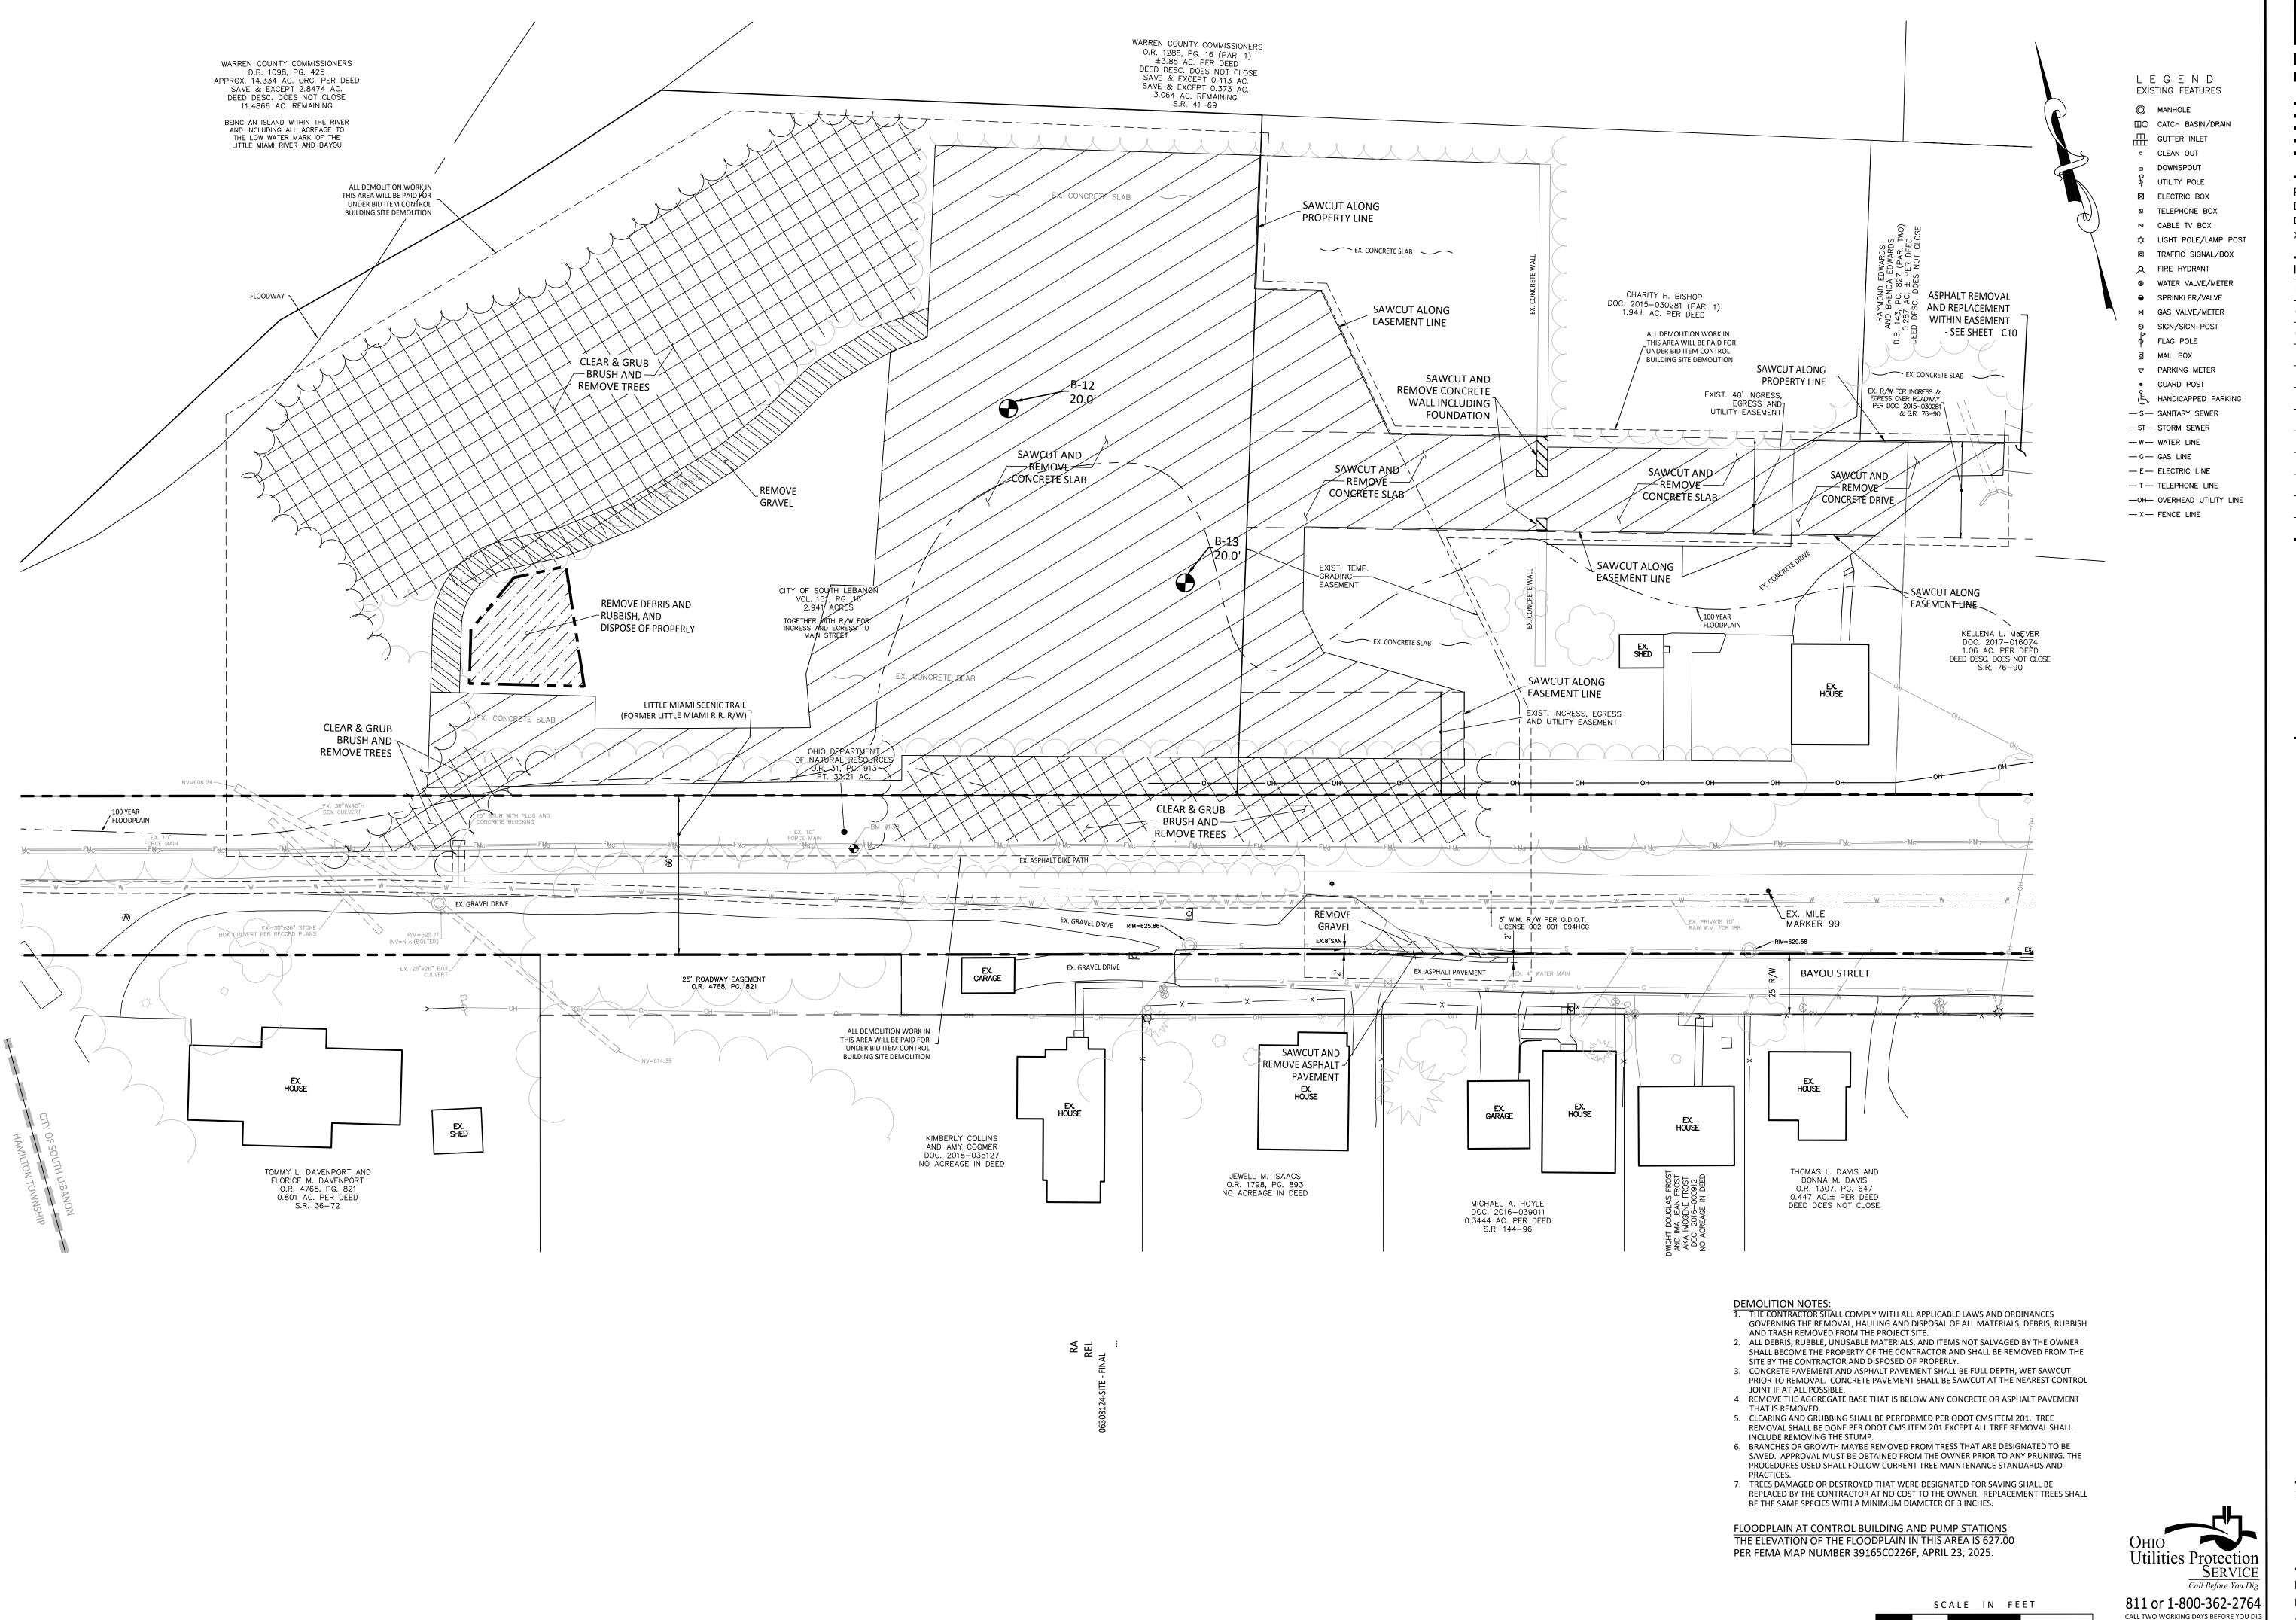
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08/28/2025

WINER CORRIDOR
UBLIC SANITARY SEWER EXTENSION
THE CITY OF SOUTH LEBANON

Sheet Title

CONTROL
BUILDING SITE DEMOLITION PLAN

4

Project Number
Drawing Scale
Sheet Number

Scale 1" = 20' umber

ieet Numb


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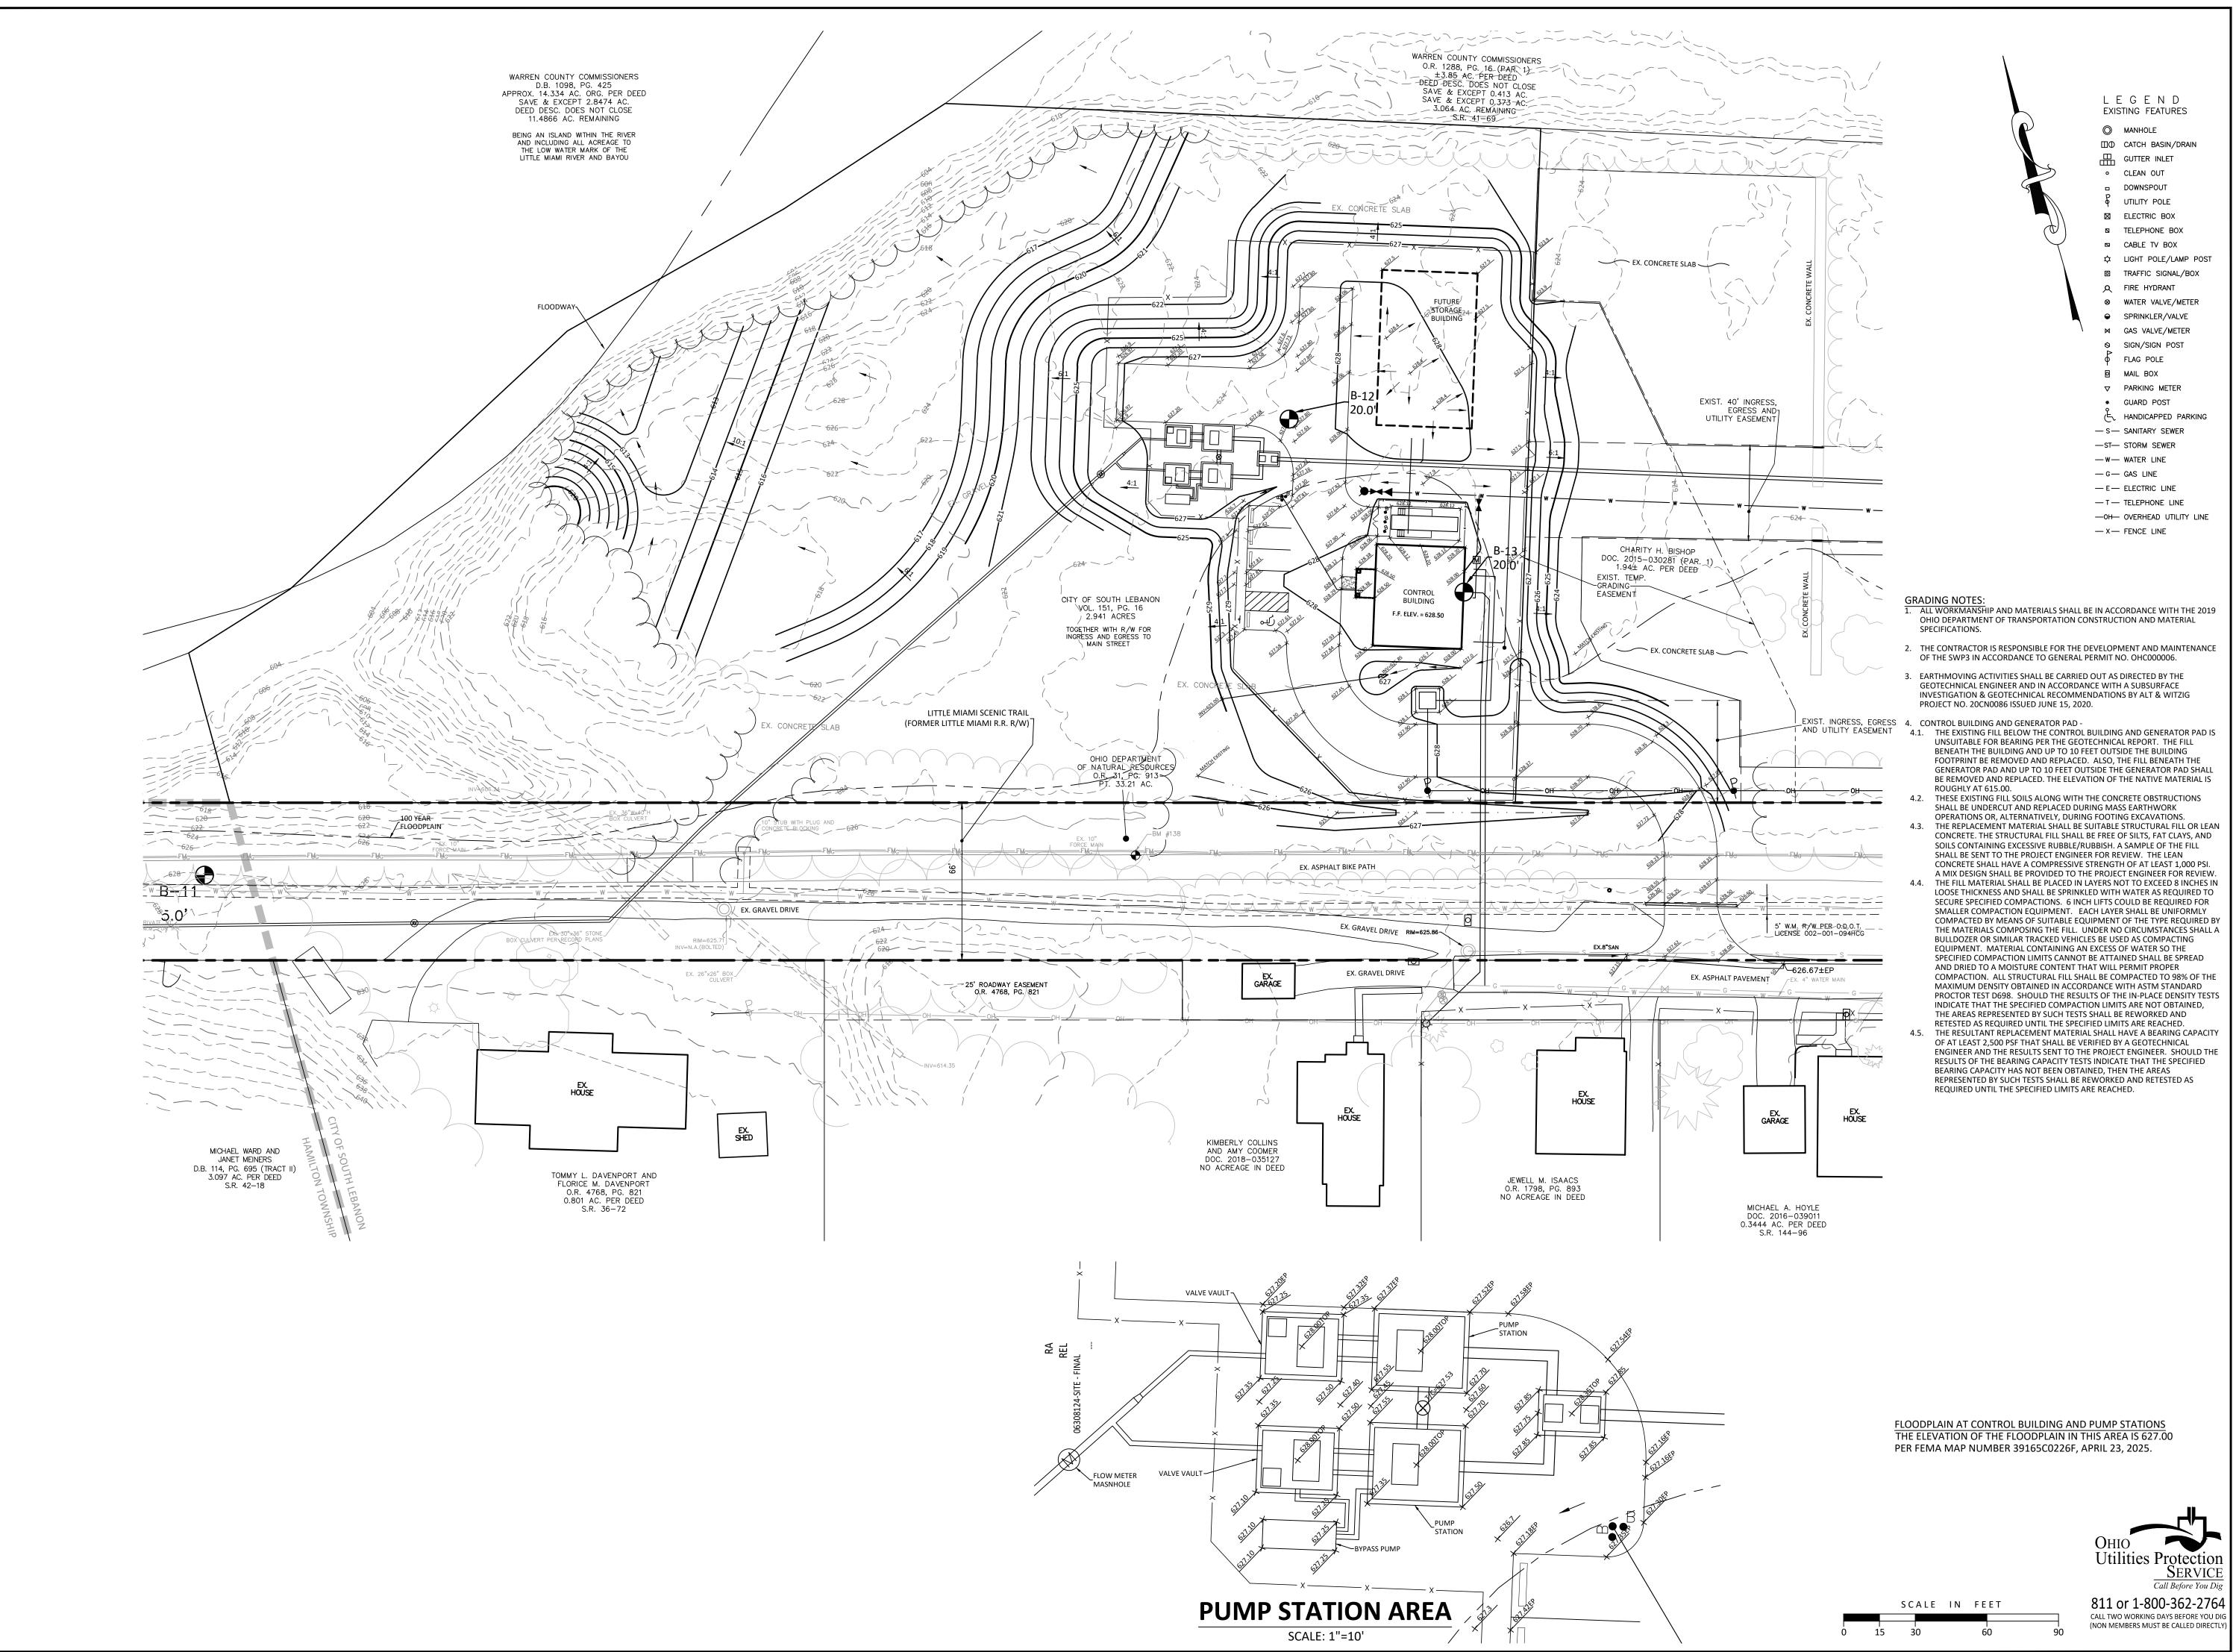
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Sheet Title

**CONTROL BUILDING SITE - SITE AND UTILITY PLAN** 

Project Number Drawing Scale Sheet Number

1" = 20' C18




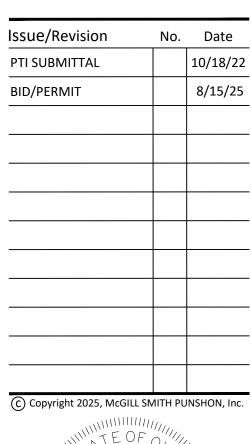

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RRID

Sheet Title

CONTROL **BUILDING SITE -GRADING PLAN** 

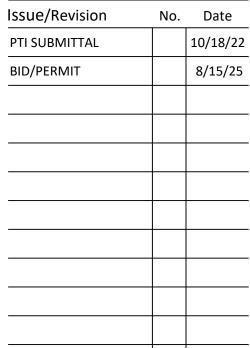Project Number Drawing Scale

**PUBLIC** 

1" = 20' C19 Sheet Number



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08/28/2025

# BLIC SANITARY SEWER EXTENSIO THE CITY OF SOUTH LEBANON

Sheet Title

MISCELLANEOUS DETAILS

Project Number 06308.12
Drawing Scale AS NOTED
Sheet Number C24
File Number 06308

	FIXTURE SCHEDULE  FIXTURE NUMBER MOUNTING TYPE:  CL - CEILING MOUNTED CV - COVE MOUNTED GR - GROUND	P - POST R - CEILING RECESSED			
FIXTURE NUMBER	RF — ROOF MOUNTED S — SUSPENDED T — TRACK UC — UNDER CABINET W  DESCRIPTION	- WALL MOUNTED WR - WALL RECESSED  MANUFACTURER	VOLTAGE	LAMPS	REMARKS
CL1	2' X 4' SURFACE MODULAR LED FIXTURE FLAT STEEL HOUSING, HIGH EFFICIENCY LEDS, 5128 LUMENS. BAKED WHITE FINISH AND PATTERN 12  ACRYLIC LENS, 0 TO 10 VOLT DIMMING.	DAY-BRITE SML SERIES OR HE WILLIAMS 12 SERIES	UNIV.	LED 4000K	40 WATTS
R2	RECESS MOUNTED 6" ROUND LED DOWNLIGHT, 1800 LUMENS, LENSED FIXTURE, WHITE FINISH, WET RATED LENS, WET RATED FIXTURE.	GE LUMINATION LDX ROUND SERIES OR PRESCOLITE LITEFRAME SERIES	UNIV.	LED 4000K	25 WATTS
CL3	GE STORAGE ROOM FIXTURE LENSED, 4' FIXTURE , 4800 LUMENS, 120 DEGREE OPTICS, DIFFUSED LENS METAL CAP.	GE ALBEO ALV2 OR ILP VS SERIES.	UNIV.	LED 4000K	33 WATTS
CL4	LED EXIT SIGN WITH WHITE THERMOPLASTIC HOUSING AND RED LETTERING AND LIGHT BAR. CEILING MOUNTED. MAINTENANCE FREE NICAD BATTERY	EXITRONIX REVOLUTION SERIES OR EVENLITE TLP SERIES	UNIV.	LED	4 WATTS
W5	INTERIOR EMERGENCY LIGHT, WHITE, MAINTENANCE FREE NICAD BATTERY, THERMOPLASTIC ENCLOSURE, TWO HEADS	EXITRONIX LED-95 SERIES OR COMPASS CU2 SERIES	UNIV.	LED	8 WATTS
W6	REMOTE EMERGENCY HEADS, EXTERIOR WEATHERPROOF RATED, BLACK COLOR, DUAL HEAD	EXITRONIX MLED SERIES OR COMPASS CWR SERIES	UNIV.	LED	3 WATTS
W7	EXTERIOR EMERGENCY LIGHT, WET LOCATION RATED, BLACK, WATERPROOF SHIELD, WET LOCATION RATED, MAINTENANCE FREE NICAD BATTERY, THERMOPLASTIC HOUSING POLYCARBONATE LENS, TWO HEADS	EXITRONIX LEM54-N4 SERIES OR COMPASS CSWEU2LED SERIES	UNIV.	LED	8 WATTS
P8	20' POLE, SQUARE, STEEL, WITH MOUNTED FIXTURE WITH SINGLE HEAD, DIE CAST ALUMINUM HOUSING WITH HINGED DOOR FRAME, HIGH EFFICIENCY LED, 10,000 LUMENS, TYPE IV DISTRIBUTION AND BLACK FINISH PHOTOCELL OPTION TO WORK DUSK TO DAWN.	GE EVOLVE SERIES EALS SERIES OR HUBBELL AIRO MICRO SERIES WITH NAFCO POLE OR HUBBELL SS20	UNIV.	LED 4000K	70 WATTS
P9	SAME AS FIXTURE "P8" EXCEPT WITH TWO HEADS 180 DEGREES APART				
Р9А	SAME AS FIXTURE "P9" EXCEPT WITH ONE HEAD INCLUDING INTEGRAL PHOTOCELL				
W10	GE 5"X8.3" TRAPEZOIDAL WALL MOUNT WITH DIE CAST ALUMINUM HOUSING WITH GASKETED DOOR FRAME. HIGH EFFICIENCY LED 1700 LUMENS, ASYMMETRIC FORWARD DISTRIBUTION, BLACK FINISH, PHOTOCELL OPTION TO WORK DUSK TO DAWN.	GE EVOLVE SERIES WALLPACK OR HUBBELL GEOPACK TRPI SERIES	UNIV.	LED 4000K	12 WATTS

		MECH	IANICAI	_ EQ	UIPI	MEN	IT C	ONNECT	ION SCHEDULE	<del>-</del> -	
SD = COI	MBINATION STARTER/DI	SCONNECT SWITCH, DC = DISCONNECT(MECHA	NICAL EQUIPMEN STAR1	T FURNISH ER, AFD =	ED WITH : ADJUS	INTEGRA TABLE F	AL MEANS REQUENCY	OF DISCONNECT) ORIVE, WP = WI	, DS = NON FUSED DISCONNECT EATHERPROOF	SWITCH, M	MS = MANUAL MOTOR STARTER, MAG = MAGNETIC MOTO
LEVEL	NO.	DESCRIPTION	VOLTS	PHASE	AMP	KW	HP	CONN	CONDUIT & WIRE SIZE	PANEL	NOTES
ITE	LSP#1	LIFT STATION PUMP #1	460	3			75.0	AFD	⟨3⟩	MDP	200AS WP(2)(5)
TE	LSP#2	LIFT STATION PUMP #2	460	3			75.0	AFD	3	MDP	200AS WP(2,X5)
TE	IG	INFLUENT GRINDER	460	3			7.5	CSD	(3)#10 + (1) 10G IN 3/4°C	MP11	30 AS WP(2)
M 109	WH-1	WATER HEATER	120	1	5.0			DC	(2)#12 + (1) 12G IN 3/4"C	RP1	
<i>I</i> 109	AC-1	AC- FURNACE & BLOWER	120	1	10.1			DS	(2)#12 + (1) 10G IN 3/4"C	RP1	30AS
TE	CU-1	CONDENSING UNIT	208	1	17.6			DS	(2)#8 + (1) 10G IN 1"C	RP1	30AS WP $\langle 2 \rangle$
M 101	EWH-1	ELECTRIC WALL HEATER	208	1		1.5		DC	(2)#12 + (1) 12G IN 3/4°C	RP1	
<i>I</i> 110	EF-1	EXHAUST FAN	120	1			FRAC	DC	(2)#12 + (1) 12G IN 3/4"C	RP1	
1 109	UH-1	UNIT HEATER	277	1		3.0		MMS	(2)#10 + (1) 10G IN 1"C	MP11	$\langle 4 \rangle$
TE		JIB CRANE WITH ELECTRIC WINCH	120	1	16.0		1.0	CSD	(2)#8 + (1) 10G IN 1"C	RP1	60AS WP $\langle 2 \rangle$
TE		MONORAILWITH ELECTRIC WINCH	120	1	20.0		1.5	CSD	(2)#8 + (1) 10G IN 1"C	RP1	60AS WP $\langle 2 \rangle$
TE	SUMP PUMP	SUMP PUMP	460	3			0.5	CSD	(3)#12 + (1) 12G IN 1"C		30AS WP $\langle 2 \rangle$
TTIC	UH-2	UNIT HEATER	277	1		3.0		MMS	(2)#10 + (1) 10G IN 1"C	MP11	$\langle 4 \rangle$
M 104	AC-2& CU-2	DUCTLESS SPLIT SYSTEM	208	1	24.9			DS	(2)#10 + (1) 10G IN 1"C	RP1	30AS WP(1)
	PANEL	L MP11 VOLT	AGE 480/277V-	3ø,4W					PANEL RP1		VOLTAGE 208/120V-3ø,4W

RM 104		DOCILES	S SPLII STS1	∟IVI		208	l l	24.9				
DAN	NEL MP11				VOLTACE .	480/277V-3	30 AW					
	ION ELECTRI	CAL DM				•	J¥,+W					
			MAIN SIZE 100 A									
	ING SURFAC		MAIN TYPE 100 A MLO									
NOT			IRU LUGS									
	200% N											
	PROVIDE	SUB-FEE	LUGS									
LOAD DESCRIPTION	LOAD KVA	CIRC BRKR/ POLE	CIRC NUMBER	CIRC BRKR/ POLE	LOAD KVA	LO	AD DESCRIP	TION				
BLDG INTERIOR LTS	0.78	20/1	1 * 2	20/1	0.09	EXI	T & EMER.	LTS				
EXTERIOR LTS	0.10	20/1	3 -*- 4	20/1	0.00	HE	AT TRACE T	APE				
SITE LTS	0.50	20/1	5* 6	20/1	0.00		SPARE					
	0.30		7 * 8	20/1	0.00		SPARE					
SUMP PUMP	0.30	20/3	9 -*- 10	20/1	0.00		SPARE					
	0.30	1	11* 12	20/1	0.00		SPARE					
	3.05		13 * 14	20/1	0.00		SPARE					
INFLUENT GRINDER	3.05	25/3	15 -*- 16	20/1	0.00		SPARE					
	3.05	1	17* 18	20/1	0.00		SPARE					
UH-1	3.00	20/1	19 * 20	20/1	0.00		SPARE					
UH-2	3.00	20/1	21 -*- 22	20/1	0.00		SPARE					
SPARE	0.00	20/1	23* 24	20/1	0.00		SPARE					
SPARE	0.00	20/1	25 * 26	20/1	0.00		SPARE					
SPARE	0.00	20/1	27 -*- 28	20/1	0.00		SPARE					
SPARE	0.00	20/1	29* 30	20/1	0.00		SPARE					
SPARE	0.00	20/1	31 * 32	20/1	0.00		SPARE					
SPARE	0.00	20/1	33 -*- 34	20/1	0.00		SPARE					
SPARE	0.00	20/1	35* 36	20/1	0.00		SPARE					
SPARE	0.00	20/1	37 * 38	20/1	0.00		SPARE					
SPARE	0.00	20/1	39 -*- 40	20/1	0.00		SPARE					
SPARE	0.00	20/1	41* 42	20/1	0.00		SPARE					
CONNECTED LOAD:		LIGHTING:	1.5	KVA								
		RECEPT:	0.0	KVA								
		EQUIP:	0.0	KVA								
		MOTOR:	10.1	KVA								
		HEATING:	6.0	KVA								
(LEFT TUB)		TOTAL:		KVA =	21.1	AMPS						

	L INF I		MAIN CITE 150 A								
	N ELECTRI				MAIN SIZE						
	IG SURFAC				MAIN TYPE	150 A MCB					
NOTE	S: PROVIDE		IRU LUGS								
	200% N										
	*INDICA	TES A GFF	E BREAKER *	* INDICAT	ES LOCK O	N BREAKER					
LOAD DESCRIPTION	LOAD KVA	CIRC BRKR/ POLE	CIRC NUMBER	CIRC BRKR/ POLE	LOAD KVA	LOAD DESCRIPTION					
SPARE	0.00	20/1	1 * 2	20/1	0.60	RM 109 WH-1					
CONTROL RM 104 REC	0.36	20/1	3 -*- 4	15/1	1.21	RM 109 AC-1					
SPARE	0.00	20/1	5* 6	30/2	1.83	SITE CU-1					
MECH RM 109 & 108 REC	0.36	20/1	7 * 8		1.83						
BREAK RM 108 REC	1.50	20/1	9 -*- 10	20/1	0.20	POWERED DOOR					
BREAK RM 108 REC	1.50	20/1	11* 12	20/1	0.20	EF-1					
BREAK RM 108 FRIDGE	1.20	20/1	13 * 14	100/2	6.00	GENERATOR PANEL					
BREAK RM108 MICROWAVE	1.20	20/1	15 -*- 16		6.00						
EXTERIOR REC	1.08	20/1	17* 18	25/2	2.59	AC-2,CU-2					
FIRE ALARM PANEL	0.20	**20/1	19 * 20		2.59						
SECURITY/ACCESS CNTRL	0.20	20/1	21 -*- 22	20/1	1.00	GEN BATTERY CHARGER					
TELECOM EQUIPMENT	1.00	20/1	23* 24	30/1	1.50	GEN BLOCK HEATER					
EWH-1	0.75	20/2	25 * 26	*20/1	0.25	HEAT TRACE TAPE					
	0.75		27 -*- 28	*20/1	0.25	SITE GATE					
CONTROL PANELS	0.80	20/1	29* 30	25/2	2.59	AC-3,CU-3					
OFFICE 103 REC	0.90	20/1	31 * 32	25/2	2.59	AC-3,C0-3					
RM 103 & 102 REC	0.90	20/1	33 -*- 34	20/1	0.00	SPARE					
CONF RM 102 REC	0.90	20/1	35* 36	20/1	0.00	SPARE					
CONF RM 102 TV REC	0.50	20/1	37 * 38	40/1	1.92	JIB CRANE					
CONF RM 102 REC	1.08	20/1	39 -*- 40	40/1	2.40	MONORAIL					
102, 107, 106 REC	1.08	20/1	41* 42	20/1	0.00	SPARE					
ONNECTED LOAD:		LIGHTING:	0.0	KVA							
		RECEPT:	16.5	KVA							
		EQUIP:	27.0	KVA							
		MOTOR:	4.5	KVA							
		HEATING:	3.8	KVA							
EFT TUB)		TOTAL:	51.8	KVA =	143.8	AMPS					

ITEM	EQUIPMENT	CONNECTED KVA									
IIEM	EQUIPMENT	LIGHTING	RECEPT	EQUIP	MOTOR	POWER	OTHER	TOTAL	AMPS		
1	RP1	0.0	16.5	27.0	4.5	0.0	3.8	51.8	144.0		
2	MP11	1.5	0.0	0.0	10.1	0.0	6.0	17.6	22.1		
3	FOUR 75HP PUMPS	0.0	0.0	0.0	304.0	0.0	0.0	304.0	382.0		
4		0.0	0.0	0.0		0.0	0.0	0.0	0.0		
								0.0	0.0		
								0.0	0.0		
	TOTAL CONNECTED	1.5	16.5	27.0	318.6	0.0	9.8	373.4	548.		
ITEM	FOURDMENT	NEC DEMAND KVA									
ITEM	EQUIPMENT	LIGHTING	RECEPT	EQUIP	MOTOR	POWER	OTHER	TOTAL	AMPS		
1	LIGHTING - 100%	1.9	ı	_	_	ı	_	1.9	2.4		
2	RECEPTACLE - NEC	_	13.3	_	_	ı	_	13.3	36.8		
3	EQUIPMENT - 100%	_	-	27.0	_	ı	_	27.0	75.0		
4	MOTOR -	_	ı	_	337.6	1	_	337.6	424.2		
5	POWER (HEATING) - 100%	_	-	_	_	0.0	_	0.0	0.0		
6	OTHER - 100%	_	_	_	_	_	9.6	9.6	26.7		

## ELECTRICAL ABBREVIATIONS

- 1				
	Α	AMPERES	HVAC	HEATING, VENTILATING AND AIR CONDITION
	AF	AMP FUSED	IC	INTERCOM
	AFF	ABOVE FINISHED FLOOR	KWC	KILOWATTS CONNECTED
	AFG	ABOVE FINISHED GRADE	KWD	KILOWATTS DEMAND
	AO	AUTO OPENER	мс	MECHANICAL CONTRACTOR
	AS	AMP SWITCH	МСВ	MAIN CIRCUIT BREAKER
	ATS	AUTOMATIC TRANSFER SWITCH	MLO	MAIN LUGS ONLY
	BAS	BUILDING AUTOMATION SYSTEM	MIN	MINIMUM
	BFF	BELOW FINISHED FLOOR	NEC	NATIONAL ELECTRICAL CODE
	BFG	BELOW FINISHED GRADE	MTG	MOUNTING
	С	CONDUIT	PC	PLUMBING CONTRACTOR
	C/B	CIRCUIT BREAKER	PNL	PANEL
	CATV	COMMUNITY ANTENNA TELEVISION (CABLE)	РВ	PUSHBUTTON
	EC	ELECTRICAL CONTRACTOR	Ø	PHASE
	ED	EXISTING TO BE DEMOLISHED	RF	REFRIDGERATOR
	EPO	EMERGENCY POWER OFF	TC	TECHNOLOGY CONTRACTOR
	EMT	ELECTRICAL METALLIC TUBING	UG	UNDERGROUND
	ER	EXISTING TO BE RELOCATED/RELOCATED	UON	UNLESS OTHERWISE NOTED
	EX	EXISTING TO REMAIN	UPS	UNINTERRUPTIBLE POWER SUPPY
	GC	GENERAL CONTRACTOR	٧	VOLTS
	GFCI	GROUND FAULT CIRCUIT INTERRUPTER	w	WIRE
	GFP	GROUND FAULT PROTECTION	WP	WEATHERPROOF
ı				

TECHNOLOGY LEGEND MOUNTING HTG. TO AFF					
SYMBOL	DESCRIPTION	UNLESS OTHERWISE NOTED			
NOTE	PROVIDE 4-INCH SQUARE BY 2-3/4-INCH DEEP DEVICE BOX AND SINGLE DEVICE RING COMBINATION WITH 1-INCH BUSHED EMT TO NEAREST ACCESSIBLE CEILING FOR ALL TELECOM AND LOW VOLTAGE SYSTEM DEVICES UNLESS NOTED OTHERWISE.  COORDINATE ROUGH-IN HEIGHTS WITH ARCHITECTURAL ELEVATIONS.				
T√	TELEVISION VIDEO OUTLET WITH (1) CATV PORT "B" INDICATES WITH (1) CATV PORT AND (1) UTP TELECOM PORT "D" INDICATES WITH (1) UTP TELECOM DATA PORT. COORDINATE WITH AV INTEGRATOR	SEE DRAWINGS			
	FLOOR BOX	FLR MTD			
B <b>∑</b>	TYPICAL TECHNOLOGY DEVICE BOX AND BUSHED CONDUIT ROUGH-IN WITH BLANK PLATE U.N.O.	18"			
▼×	DATA OUTLET. "X" REPRESENTS QTY OF UTP TELECOM PORTS / "CLG" REPRESENTS CEILING MOUNTED	15" BOTTOM			
<u> </u>	PROVIDE BUSHED STEEL SLEEVE. PROVIDE UL LISTED FIRE STOP ASSEMBLY AT RATED BARRIERS. PROVIDE QTY AS REQUIRED TO MATCH ABBUTTED CABLE TRAY UNO	SEE DRAWINGS			
(CR)	CARD READER - ACCESS CONTROL "K" IDENTIFIES WITH INTEGRAL KEYPAD, "S" IDENTIFIES WITH SWIPE, "M" IDENTIFIES MULLION PROFILE	48"			

## MECHANICAL EQUIPMENT CONNECTION NOTES

- POWER FOR INDOOR UNIT FED FROM OUTDOOR UNIT. PROVIDE WIRING FOR BOTH AS INDICATED ON SCHEDULE AND WEATHERPROOF DISCONNECT SWITCH. WEATHER PROOF DISCONNECT SWITCH BY ELECTRICAL CONTRACTOR. COORDINATE LOCATION AND WIRE AS DIRECTED BY THE MECHANICAL CONTRACTOR.
- REFER TO SHEET E4 FOR OVERCURRENT PROTECTION AND FEEDER SIZE. DISCONNECT SWITCH BY ELECTRICAL CONTRACTOR. COORDINATE LOCATION AND WIRE AS DIRECTED BY MECHANICAL CONTRACTOR.
- 5. AFD WITH BYPASS FURNISHED BY OTHERS, INSTALLED BY EC..

SYMBOL	DESCRIPTION  WALL MTD SPECIAL OUTLET AS DECUMPED.	OFF DRAWN 17.7	
<b>⊢▲</b>	WALL MTD SPECIAL OUTLET AS REQUIRED FLOOR BOX	SEE DRAWINGS FLR MTD	
<del>)</del>	WIRED JUNCTION BOX	SEE DRAWINGS	
$\rightarrow$	SIMPLEX RECEPTACLE - SEE DWGS FOR NEMA CONFIGUR	RATION SEE DRAWINGS	
<del>-</del>	"TL" = TWISTLOCK	1 QII	
<del></del>	DUPLEX RECEPTACLE  "T" = TAMPER PROOF  "GE" - GPOLING FALLT INTERI	18"	
	"GF" = GROUND FAULT INTERF "WP" = WEATHERPROOF GROU		
<b>=</b>	DOUBLE DUPLEX RECEPTACLE	18"	
	"T" = TAMPER PROOF "GF" = GROUND FAULT INTER	RUPTER	
$\blacksquare$	208V RECEPTACLE - SEE DWGS FOR NEMA CONFIGURATI	ION 18"	
#	DUPLEX RECEPTACLE	8" AB COUNTER TOP	
	"T" = TAMPER PROOF "GF" = GROUND FAULT INTER	RUPTER	
#	DOUBLE DUPLEX RECEPTACLE	8" AB COUNTER TOP	
	"T" = TAMPER PROOF "GF" = GROUND FAULT INTER	RUPTER	
	POKE-THRU W/ DOUBLE DUPLEX RECEPTACLES, DATA	FLR MTD	
	PER SYSTEMS SHEETS UNLESS NOTED OTHERWISE	"	
<del></del>	DOUBLE DUPLEX RECEPTACLE, EMERGENCY  DUPLEX RECEPTACLE, EMERGENCY	18" 18"	
<del>-</del>	DOUBLE DUPLEX RECEPTACLE, EMERGENCY	8" AB COUNTER TOP	
<u>-</u> =■	DUPLEX RECEPTACLE, EMERGENCY	8" AB COUNTER TOP	
<b>−</b> ⊕CLG	DUPLEX RECEPTACLE, IN HANDI-BOX ON FLEXIBLE WHIP	FLUSH MTD IN CEILING	
①——	PLUGMOLD, RECEPT AT 12 INCH CENTER TO CENTER	ADJACENT EQUIPMENT	
<b>⊍</b> -	COORD MOUNTING HEIGHT W/ ARCH DETAIL		
	JUNCTION BOX		
<del>J</del> ©	GROUND BAR	56"	
$\leftrightarrow$	TOGGLE SWITCH - SINGLE  "3" = 3-WAY	48"	
	$^{"}4"$ = 4-WAY		
	"K" = KEYED "D" = DIMMER "CC" - OCCUPANCY SEN		
	"OS" = OCCUPANCY SEN "M" = MANUAL MOTOR S		
<b>(S)</b>	OCCUPANCY SENSOR. DUAL TECHNOLOGY DETECTION	CLG MTD	
⊚ <sup>d</sup>	OCCUPANCY SENSOR. DUAL TECHNOLOGY DETECTION. PROVIDE WITH PHOTOCELL W/ DIMMING	CLG MTD	
<del>3</del> 03	WALL MOUNTED OCCUPANCY SENSOR	WALL MTD	
08	CEILING MOUNTED DAYLIGHTIING CONTROL SENSOR	CLG MTD	
P	POWER PACK	AB CLG	
<b>3</b>	MOTOR - 1 PHASE	AS REQ'D	
$\widetilde{\mathfrak{A}}$	MOTOR - 3 PHASE	AS REQ'D	
<b>⊗</b> ↑	CLG MTD EXIT LIGHT W/ DIRECTIONAL ARROWS	CLG MTD	
<b>↑</b> ⊖↑	CLG MTD EXIT LIGHT W/ DIRECTIONAL ARROWS	CLG MTD	
<del>1</del> ⊗↑	WALL MTD EXIT LIGHT W/ DIRECTIONAL ARROWS	AB DOOR	
<del>1</del> - <b>\$</b>	SIDE MTD EXIT LIGHT W/ DIRECTIONAL ARROWS  ELECTRICAL PANEL (DASHED LINE INDICATES	AB DOOR	
	WORKING CLEARANCE)	72" TO TOP	
	SAFETY SWITCH	AS REQ'D	
	COMBINATION MOTOR STARTER	AS REQ'D	
<b>⊜</b> <b>⊜</b> EPO	PUSHBUTTON  EMERGENCY POWER OFF PUSHBUTTON	48" 48"	
<b>⊜</b> EPO <b>F</b>	FIRE ALARM MANUAL PULL STATION	48" 48"	
Ed.	FIRE ALARM SIGNAL - AUDIO/VISUAL DEVICE	MIN 80" AFF TO LENS BTN	
E\(-	FIRE ALARM SIGNAL - VISUAL DEVICE	MIN 80" AFF TO LENS BT	
(F)	SMOKE DETECTOR HEAT DETECTOR	CLG MTD	
⊕ <b>⊱</b> —×	DUCT MOUNTED SMOKE DETECTOR	CLG MTD COORD W/MECH	
ZEZ X	"SA" = SUPPLY AIR "BA" = RETURN AIR	OGGILD WIMEGIT	
IΤΩ	TAMPER SWITCH	AS REQ'D	
Ts Fs	FLOW SWITCH	AS REQ'D	
<u> </u>	MAGNETIC DOOR HOLDER	AS REQ'D	
<u>r</u>	FIRE ALARM SECURITY SYSTEM DOOR RELEASE	AS REQ'D	
FB	FIRE ALARM BEAM DETECTOR	AS REQ'D	
PIV FACP	FIRE ALARM POST INDICATING VAVLE FIRE ALARM CONTROL PANEL	AS REQ'D 72" TO TOP	
FAAP	FIRE ALARM ANNUNCIATOR PANEL	60"	
	LIGHT FIXTURE, TYPE AS NOTED ON FLOOR PLANS (R1, ET	<sup>-</sup> C)	
	SEE LIGHT FIXTURE SCHEDULE.		
	(HANGING FIXTURE)		
0	(DOWNLIGHT)		
<u></u>	(WALL MOUNTED DOWNLIGHT)		
<del>1</del> 0	(WALL MOUNTED DOWNLIGHT)		
	LIGHT FIXTURE, TYPE AS NOTED ON FLOOR PLANS (R1, ETC) SEE FIXTURE		
	SCHEDULE. CONNECTED TO LIFE SAFETY OR CRITICAL PO	OWER.	

(DOWNLIGHT)

(WALL MOUNTED FIXTURE) (WALL MOUNTED DOWNLIGHT)



■ Engineering ■ Landscape Architecture ■ Surveying

Project Manager CSW Drawn By

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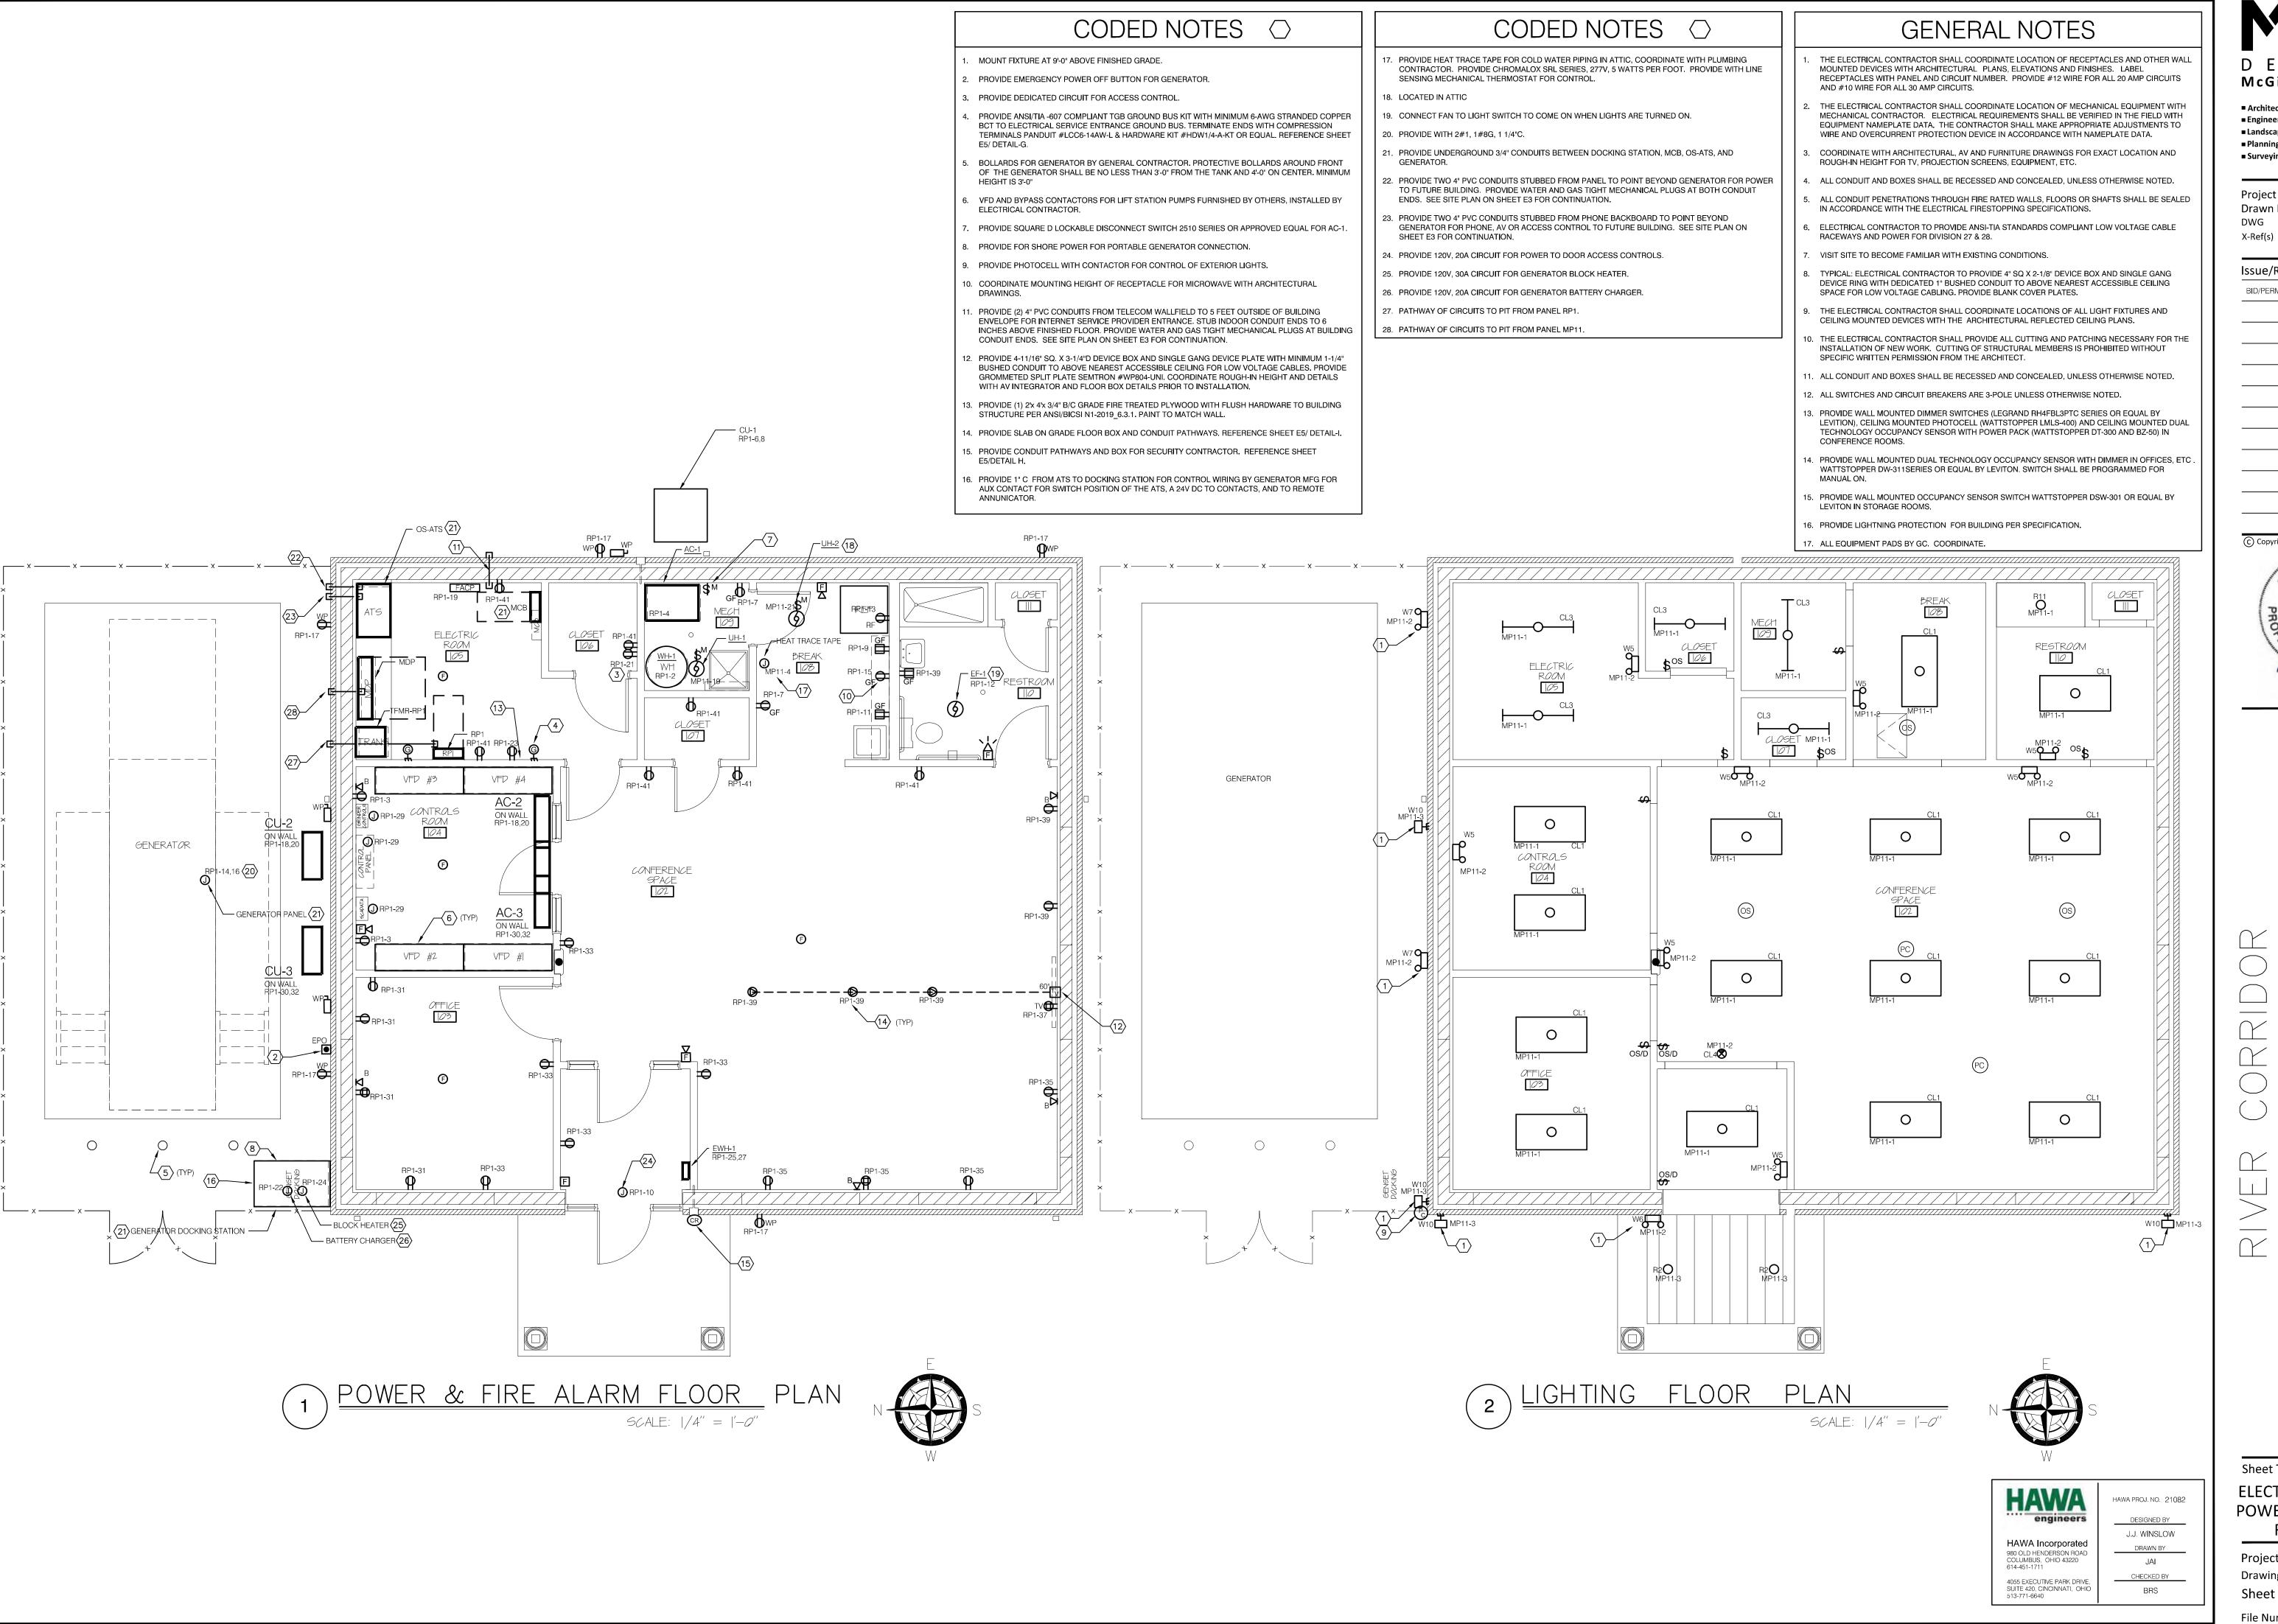
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Sheet Title

ELECTRICAL SCHEDULES, **LEGENDS & ABBREVIATIONS** 

> 06308.12 Project Number AS NOTED Drawing Scale Sheet Number

E1



3700 Park 42 Drive

■ Architecture ■ Engineering Suite 190B ■ Landscape Architecture Cincinnati OH 45241 ■ Planning Phone 513.759.0004 ■ Surveying www.mspdesign.com

**Project Manager** DCC CSW Drawn By NONE

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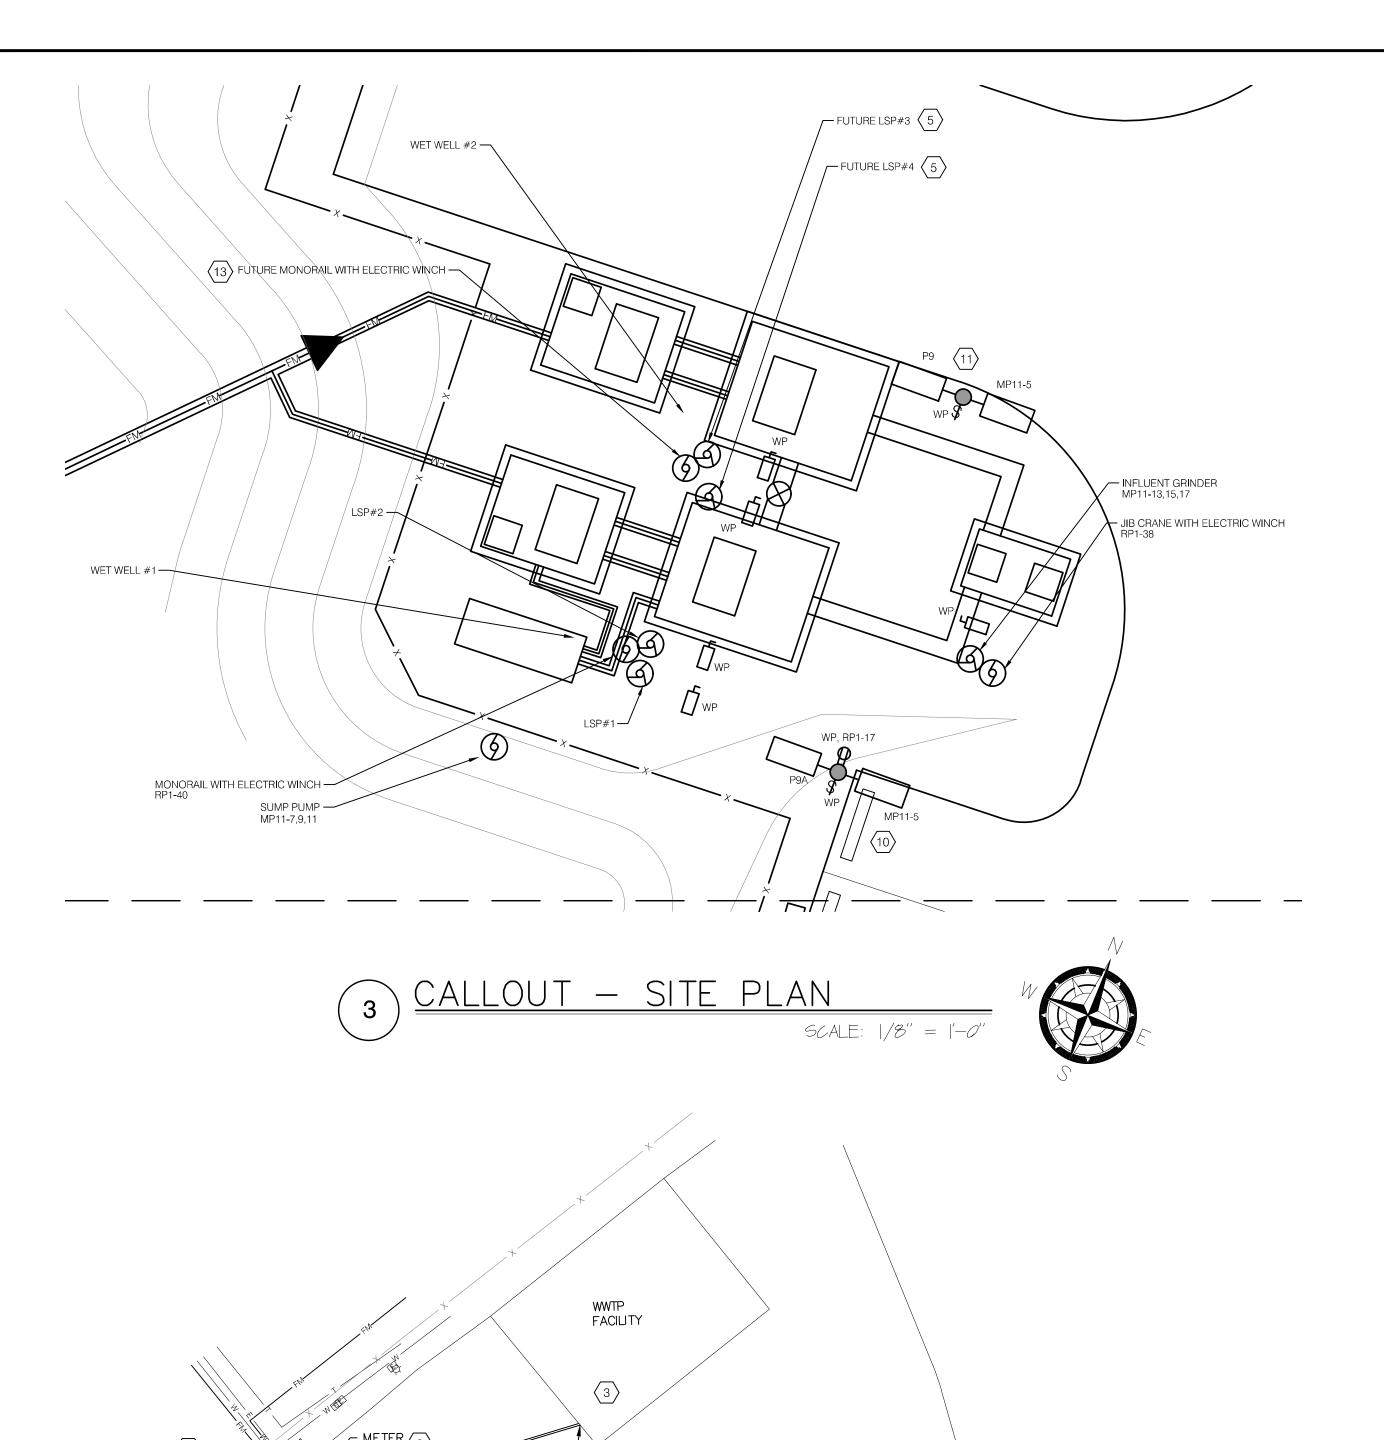
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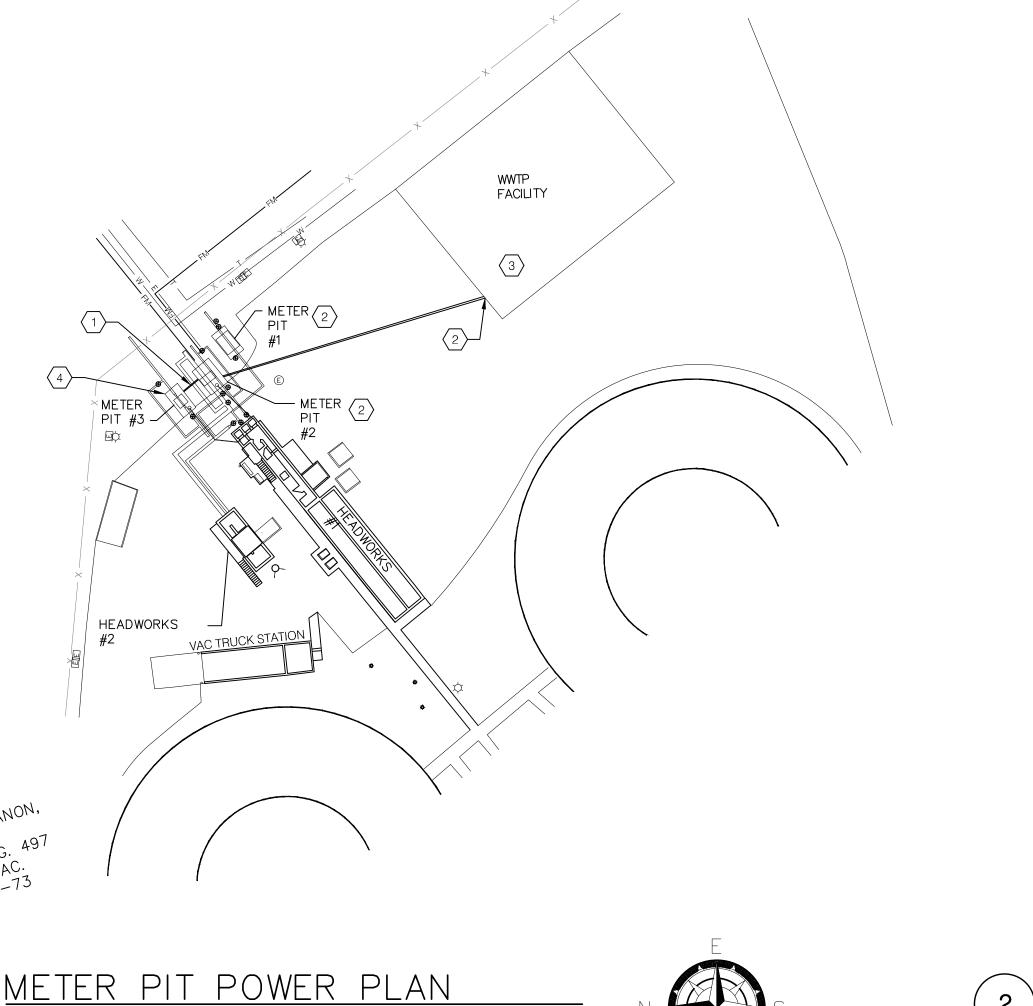
ELECTRICAL LIGHTING, POWER, & FIRE ALARM FLOOR PLAN

06308.12

AS NOTED

Project Number Drawing Scale Sheet Number





SCALE: |'' = 40'-0''

SITE PLAN

CODED NOTES  $\bigcirc$ 

PROVIDE TWO 3/4" CONDUITS FROM METER PIT #2 TO METER PIT #3, ONE FOR POWER, ONE FOR CONTROL WIRING.

2. REUSE EXISTING POWER AND CONTROL CONDUITS FROM METER PITS #2 & #1 BACK TO THE OFFICE AND MAINTENANCE FACILITY (WTTP FACILITY).

DISCONNECT AND REMOVE POWER WIRING FROM METER PITS #1 & #2 BACK TO SOURCE IN OFFICE AND MAINTENANCE FACILITY (WTTP FACILITY). PROVIDE NEW 2#10 XHHW-2, 1#10 XHHW-2 G WIRE FROM SOURCE TO METERS IN PITS #1, #2, & #3. PROVIDE GF BREAKER AT PANEL FOR CIRCUIT THAT FEEDS THESE METERS.

DISCONNECT AND REMOVE EXISTING CONDUIT & WIRE IN METER PIT #3. PROVIDE ONE NEW 3/4" CONTROL AND ONE 3/4" POWER CONDUITS IN METER PIT #3 FROM PIT TO OFFICE AND MAINTENANCE BUILDING. PROVIDE ALL NEW CONTROL WIRE FOR WET LOCATION - HONEYWELL 16 AWG 4/C OR APPROVED EQUAL FROM METER PIT #3 TO METER PIT #2. ELECTRICAL CONTRACTOR SHALL INSTALL FLOW METER FURNISHED BY OWNER IN METER PIT #3. PROVIDE 2#10, 1#10G, 3/4" CONDUIT BACK TO OFFICE AND MAINTENANCE FACILITY (WTTP FACILITY).

ADD TWO 1 1/4" CONDUITS FOR FUTURE LIFT STATION PUMPS WITH PULLSTRINGS TO LOCATION OF FUTURE DISCONNECTS.

APPROXIMATE LOCATION OF UTILITY PAD MOUNTED TRANSFORMER AND METER ENCLOSURE. PROVIDE 10'-0" CLEARANCE AROUND TRANSFORMER TO MEET DUKE ENERGY REQUIREMENTS.

PROVIDE (2) 5" SCHEDULE 40 PVC CONDUITS FOR ELECTRIC POWER.

PROVIDE (2) 4" SCHEDULE 40 PVC CONDUITS FOR TELECOM SERVICE ENTRANCE.

. APPROXIMATE LOCATIONS OF DUKE UTILITY POLE.

0. POLE FIXTURE ON EAST SIDE SHALL BE PHOTOCELL CONTROLLED, FIXTURE ON WEST SIDE SHALL BE SWITCH CONTROLLED.

1. BOTH POLE FIXTURES SHALL BE SWITCH CONTROLLED.

12. PROVIDE 2#12, 1#12G, 1" PVC CONDUIT FOR POWER TO GATE. COORDINATE EXACT LOCATION WITH CONSTRUCTION MANAGER. PROVIDE A 1" PVC CONDUIT FROM GATE TO CONTROL BUILDING FOR CONTROL WIRING BY OTHERS.

3. PROVIDE 1" CONDUIT FROM PANEL "RP1" FOR FUTURE LIFT STATION MONORAIL.

14. PROVIDE TWO 4" PVC CONDUITS WITH PULL STRING FROM NEW CONTROL BUILDING TO FUTURE BUILDING LOCATION.

5. PROVIDE 18"x18" IN GROUND HANDHOLE BOX FOR ELECTRICAL. REFERENCE SHEET E6/DETAIL C.

16. PROVIDE 4'x4' IN GROUND HANDHOLE BOX FOR ELECTRICAL. REFERENCE SHEET E6/DETAIL C.

17. PATHWAY OF BRANCH CIRCUITS TO PITS. REFERENCE SHEET E5/DETAIL E.

18. PATHWAY OF CONTROL CIRCUITS TO PITS. REFERENCE SHEET E6/DETAIL A.

19. PATHWAY OF CIRCUITS TO EAST SIDE BRANCH CIRCUITS. REFERENCE SHEET E6/DETAIL B.

20. PROVIDE 4'X4' IN GROUND HANDHOLE BOX FOR TELECOM. REFERENCE SHEET E6/DETAIL D.

## GENERAL NOTES

1. THE ELECTRICAL CONTRACTOR SHALL COORDINATE LOCATION OF RECEPTACLES AND OTHER WALL MOUNTED DEVICES WITH ARCHITECTURAL PLANS, ELEVATIONS AND FINISHES. LABEL RECEPTACLES WITH PANEL AND CIRCUIT NUMBER. PROVIDE #10 WIRE FOR ALL 20 AMP CIRCUITS AND #8 WIRE FOR ALL 30 AMP CIRCUITS.

with Panel and Circuit Number. Provide #10 wire for all 20 amp Circuits and #8 wire for all 30 amp Circuits.

2. The Electrical Contractor shall coordinate location of Mechanical Equipment with

MECHANICAL CONTRACTOR. ELECTRICAL REQUIREMENTS SHALL BE VERIFIED IN THE FIELD WITH EQUIPMENT NAMEPLATE DATA. THE CONTRACTOR SHALL MAKE APPROPRIATE ADJUSTMENTS TO WIRE AND OVERCURRENT PROTECTION DEVICE IN ACCORDANCE WITH NAMEPLATE DATA.

COORDINATE WITH ARCHITECTURAL, AV AND FURNITURE DRAWINGS FOR EXACT LOCATION AND ROUGH-IN HEIGHT FOR TV, PROJECTION SCREENS.

ALL CONDUIT AND BOXES SHALL BE RECESSED AND CONCEALED, UNLESS OTHERWISE NOTED.

ALL CONDUIT PENETRATIONS THROUGH FIRE RATED WALLS, FLOORS OR SHAFTS SHALL BE SEALED IN

ACCORDANCE WITH THE ELECTRICAL FIRESTOPPING SPECIFICATIONS.

ELECTRICAL CONTRACTOR TO PROVIDE PATHWAYS FOR THE TELEPHONE/DATA WIRING BY OTHERS.


VISIT SITE TO BECOME FAMILIAR WITH EXISTING CONDITIONS.

3. THE ELECTRICAL CONTRACTOR SHALL PROVIDE ALL CUTTING AND PATCHING NECESSARY FOR THE INSTALLATION OF NEW WORK. CUTTING OF STRUCTURAL MEMBERS IS PROHIBITED WITHOUT SPECIFIC WRITTEN PERMISSION FROM THE ARCHITECT.

9. ALL CONDUIT AND BOXES SHALL BE RECESSED AND CONCEALED, UNLESS OTHERWISE NOTED.

10. ALL SWITCHES AND CIRCUIT BREAKERS ARE 3-POLE UNLESS OTHERWISE NOTED.11. COORDINATE WITH BECKMAN ENVIRONMENTAL SERVICES DRAWINGS FOR WORK FOR THE PUMP

FATION.

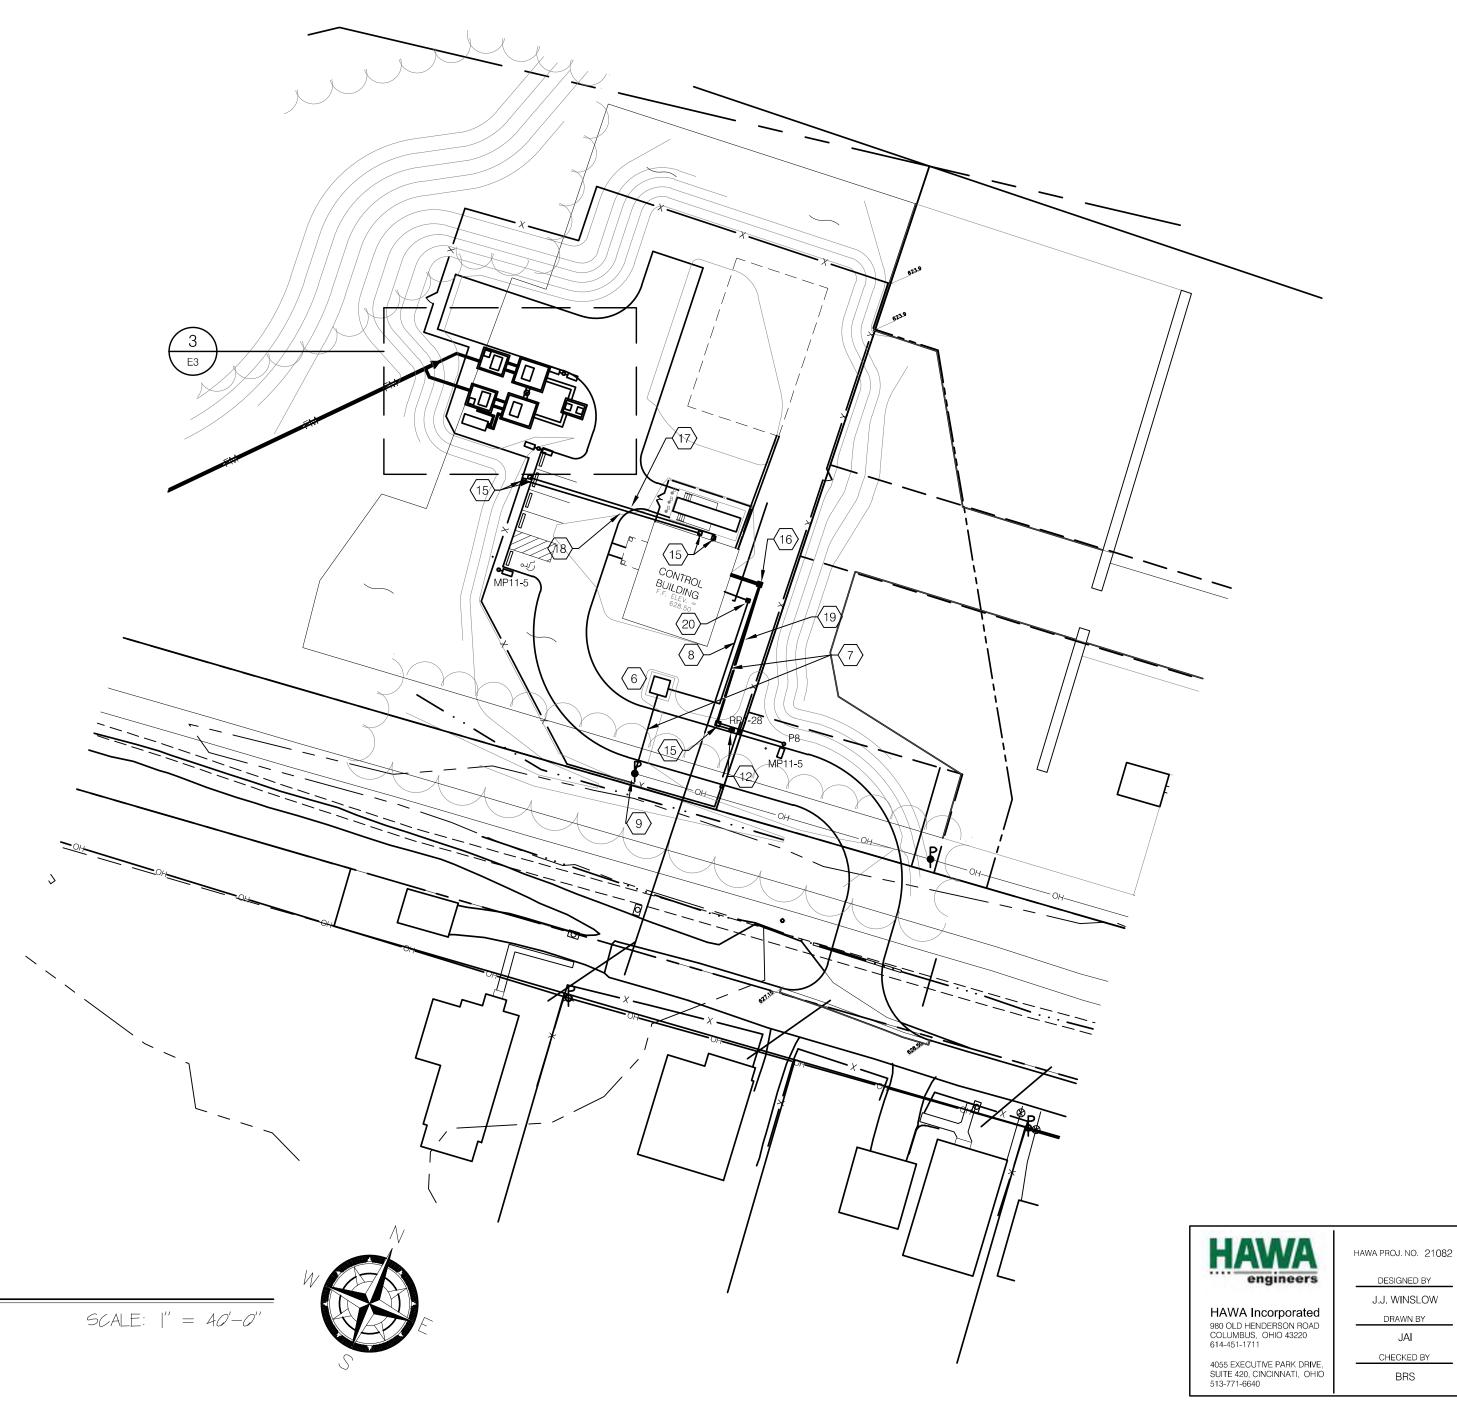

D E S I G N McGill Smith Punshon

■ Architecture
■ Engineering
■ Landscape Architecture
■ Planning
■ Surveying
■ Surveying
■ 3700 Park 42 Drive
■ Suite 190B
Cincinnati OH 45241
■ Phone 513.759.0004
■ www.mspdesign.com

Project Manager DCC
Drawn By CSW
DWG
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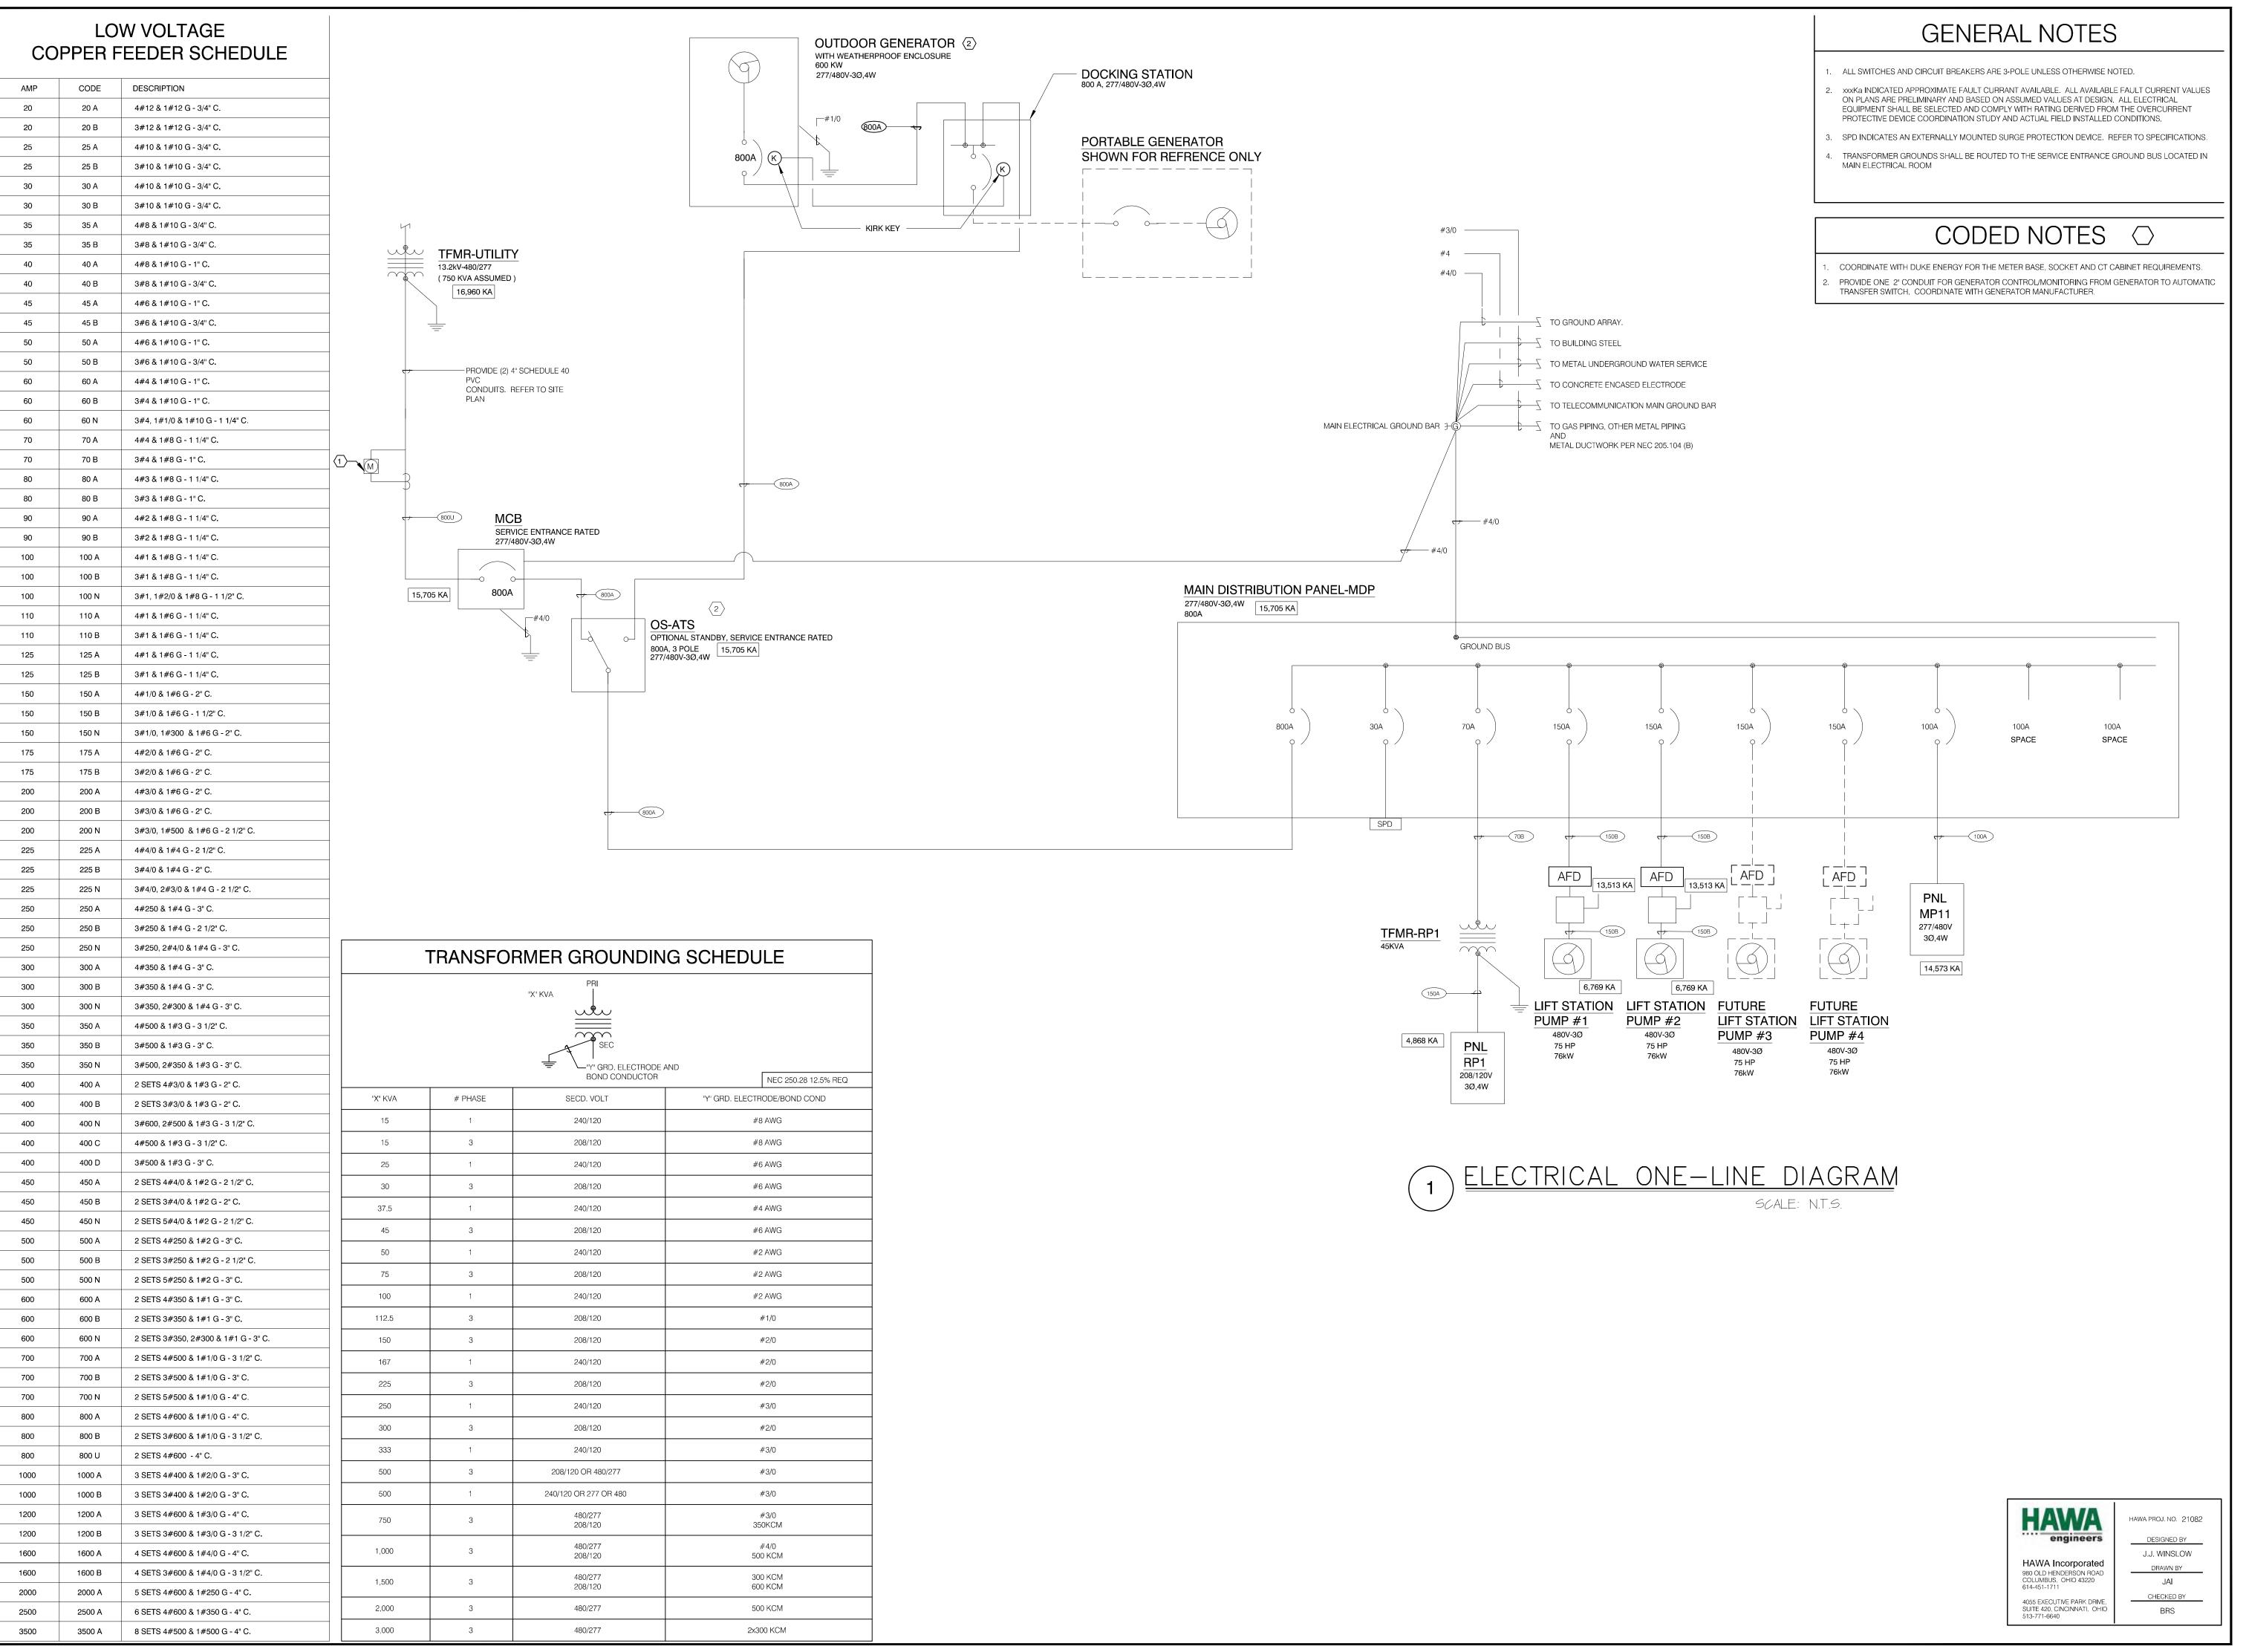
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ELECTRICAL SITE PLAN & METER PIT

Project Number 06308.12
Drawing Scale AS NOTED
Sheet Number E3

File Number

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McGill Smith Punshon ■ Architecture 3700 Park 42 Drive ■ Engineering Suite 190B ■ Landscape Architecture Cincinnati OH 45241

Phone 513.759.0004 www.mspdesign.com

DCC

CSW

NONE

Project Manager Drawn By X-Ref(s)

■ Planning

■ Surveying

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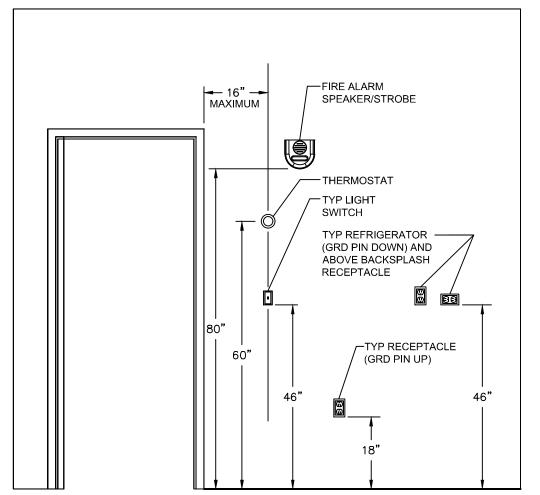



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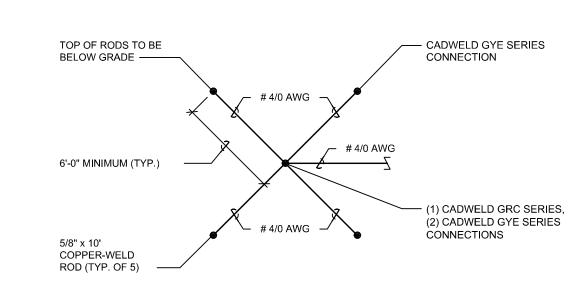
**ELECTRICAL ONE-LINE** DIAGRAM

06308.12 Project Number **AS NOTED** Drawing Scale **Sheet Number** 

E4





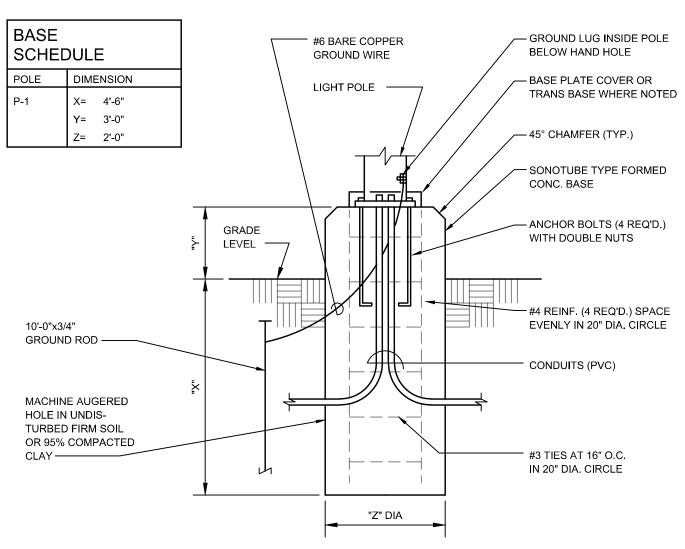

## LIGHT POLE BASE DETAIL



FINISHED GRADE

WARNING TAPE.


DRAINAGE FILL

(4) RIGID, 1-1/2" PVC (3) RIGID, 1" PVC

(2) RIGID, 3/4" PVC CONDUITS.

TRENCH WIDTH

AS REQUIRED

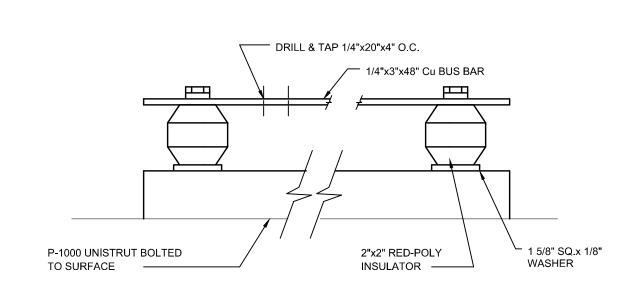


SERVICE ENTRANCE & TELECOM GROUND BUS DETAIL

## DETAIL NOTES:

**TECHNOLOGY GROUNDING DETAIL** 

**NEW TGB KIT** 


- DIVISION 26 SHALL RE-TERMINATE ALL TELECOM GROUNDING BACKBONE CONNECTIONS WITH REQUIRED COMPRESSION TERMINALS WITH 2-HOLE
- PADS AND INSPECTION PORTS. TELECOM BUSBARS TO BE LISTED MINIMUM 2" X 12" X 1/4" TIN PLATED
- COPPER WITH ANSI/TIA-607 DRILL PATTERN. SYSTEMS GROUNDING BACKBONE CABLING AND BUSBAR KITS ARE BY
- DIVISION 26 PER ANSI/TIA-607-B STANDARD. PROTECT BCT AND TBB IN PVC CONDUIT AS PERMISSIBLE BY NEC. WHEN METALLIC CONDUIT IS PROVIDED 3' OR LONGER TO PROTECT BCT/TBB OR GE CONDUCTORS, THE CONDUCTORS MUST BE BONDED TO THE CONDUIT WITH LISTED INSULATED THROAT GROUND BUSHINGS AND A MINIMUM 6AWG COPPER CONDUCTOR AND A GAUGE MATCHING LISTED
- H-TAP OR C-TAP DEVICE. DIVISION 26 TO FIELD VERIFY ALL EXISTING CONDUCTOR SIZES PRIOR TO ORDERING COMPRESSION CONNECTORS.
- A. NEW "BCT" TO ELECTRICAL SERVICE ENTRANCE GROUND BUS IN NON-METALLIC OR BONDED CONDUIT. TEST ENTIRE GROUNDING SYSTEM
- BACKBONE RESISTANCE. B. TYPICAL COMMUNICATIONS GROUNDING BACKBONE LABEL PANDUIT
- #LTYK. PROVIDE AT ALL BACKBONE TERMINATIONS. C. TYPICAL 6 AWG COPPER 2-HOLE COMPRESSION TERMINAL WITH
- INSPECTION PORT. D. 6 AWG STRANDED COPPER TEBC WITH GREEN JACKET BY ISP AND/ OR
- E. TYPICAL TGB BUSBAR KIT BY DIVISION 26 PER DIVISION 27 SPECIFICATIONS.

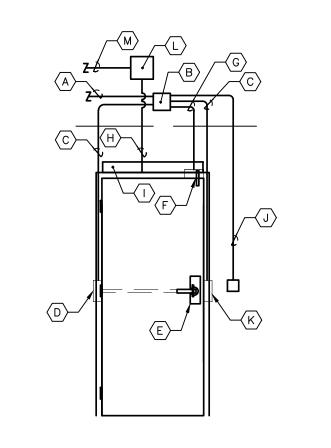

- COORDINATE PATHWAYS AND CABLES WITH ARCHITECTURAL DOOR HARDWARE
- CENTRAL POWER SUPPLY MAY BE CENTRAL AT TELECOM ROOMS OR AT EACH
- LOCAL POWER SUPPLY FOR DOOR OPERATOR HARDWARE IS TYPICAL.
- SECURITY AND FIRE ALARM CONTRACTORS.

A. 1" CONDUIT STUB AND SECURITY LOW VOLTAGE CABLES TO ACCESS CONTROL

- HARDWARE, AND SECURITY CONTRACTOR LV CABLES UNO.
- C. 3/4" BUSHED CONDUIT TO POWER TRANSFER BAR/ ELECTRIFIED HINGE FRAME
- D. POWER TRANSFER BAR OR ELECTRIFIED HINGE WHERE REQUIRED.
- F. RECESSED DOOR POSITION SWITCH WITHIN 6" OF SLAB EDGE WHERE REQUIRED.
- G. 1/2" BUSHED CONDUIT TO DOOR POSITION SWITCH.
- H. 3/4" LOCAL POWER CONDUIT TO DOOR OPERATOR AS REQUIRED.
- NOTED ON SHEETS.
- WHERE REQUIRED.
- M. LOCAL 120VAC WHERE REQUIRED.
- ACCESS CONTROL DOOR TYPICAL PATHWAYS BY DIV. 26

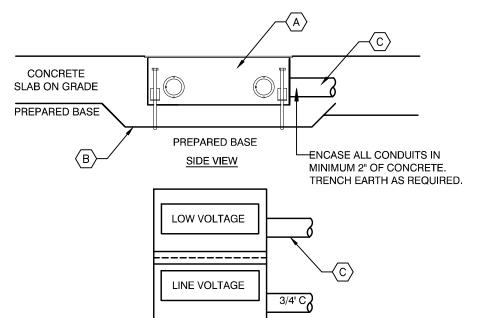

TYPICAL SLAB ONO GRADE FLOOR BOX DETAIL

TOP VIEW

BY DIV. 26

EQUIPMENT EDGE —

1/2" CHAMFER (TYP.) —

FINISHED

SURFACE -

#5 FOUNDATION REBAR —

DETAIL NOTES:

CONDUCTOR SIZE

AND CONTINUATION

**GENERATOR PAD DETAIL** 

CONCRETE

FOUNDATION

— CADWELD TYPE RR OR RD

- #5 FOUNDATION REBAR SEE NOTE BELOW

6x6 - W2.9xW2.9 (42#) WWF

— GRAVEL COMPACTION SUBASE

BOTTOM OF PAD SHALL

BE BELOW THE FROST

LINE. ALL REBARS SHALL

BE BONDED TOGETHER,

WITH TIE WIRES.

- FLOOR BOX AND ALL ASSOCIATED CONDUIT PATHWAYS
- ARE BY DIVISION 26. ROUTE CONDUIT AS DIRECT AS POSSIBLE. NMT 180 DEGREES OF CONDUIT BEND BETWEEN END POINTS.
- PROVIDE 200# PULL STRING IN LV CONDUITS. PROVIDE DIVIDERS BETWEEN LINE VOLTAGE AND LOW VOLTAGE AS APPLICABLE.
- PROVIDE BLANK COVER PLATES FOR UNUSED DEVICE OPENINGS.
- ENCASE ALL CONDUITS AND BOX WITH MINIMUM 2" OF CONCRETE. TRENCH AND SUPPORT BOX AND CONDUITS AS REQUIRED.
- A. PROVIDE FSR FL-500P-4 FLOOR BOX ASSEMBLY AS INDICATED. INSTALL FLUSH WITH FINISH FLOOR ADJUSTED FOR BOX COVER FLOOR FINISH DETAILS. PROVIDE TEMPORARY CONSTRUCTION COVER & PROVIDE ALSO U-ACCESS UL SCRUB WATER RATED FINISH COVER TO FINAL FLOOR INSTALLATION. COORDINATE COVER FINISH WITH ARCHITECT PRIOR TO ORDER. INSTALL PER MANUFACTURERS PUBLISHED INSTRUCTIONS.
- B. PROVIDE FSR #FLGRD4 POUR PAN AS RECOMMENDED BY MANUFACTURER. PROVIDE MINIMUM 2" CONCRETE BETWEEN BOX BASE AND PREPARED BASE.
- C. PROVIDE MINIMUM 1-1/4" PVC BUSHED CONDUITS OR AS NOTED. DO NOT CONNECT LV CONDUITS IN SERIES BETWEEN FLOOR BOXES U.N.O.



SUITE 420, CINCINNATI, OHI 513-771-6640 BRS

Sheet Title ELECTRICAL DETAILS Project Number Drawing Scale

File Number

**Sheet Number** 

06308.12

AS NOTED

McGill Smith Punshon

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08/13/2025

■ Architecture ■ Engineering

■ Planning

■ Surveying

Drawn By

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X-Ref(s)

■ Landscape Architecture

Project Manager

Issue/Revision

3700 Park 42 Drive

Cincinnati OH 45241

Phone 513.759.0004

www.mspdesign.com

No. Date


08/15/2025

Suite 190B

DCC

CSW

NONE

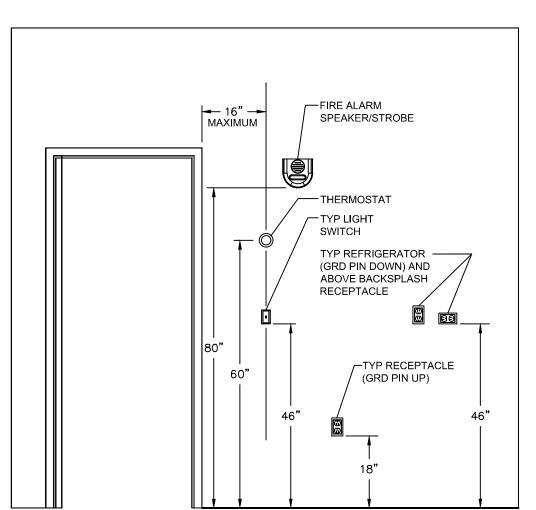


TYPICAL DEVICE LAYOUT



**GROUND ROD DETAIL** 


DETECTABLE UNDERGROUND

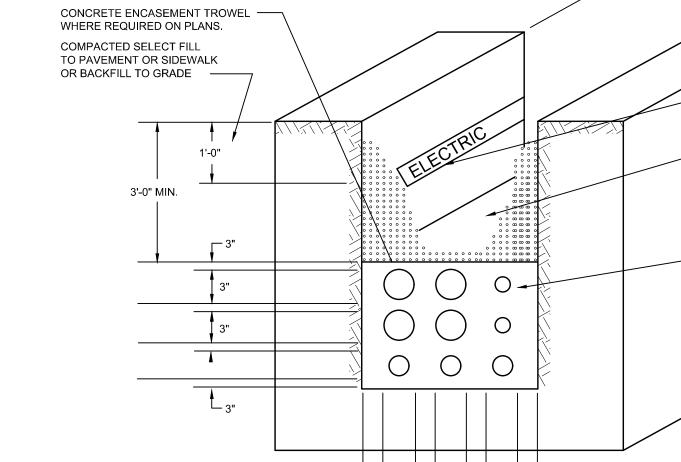


**ELECTRICAL DUCT BANK DETAIL-WEST** 

DETAIL NOTES:


- SCHEDULE AND ACCESS CONTROL CONTRACTOR. DOOR BY SECURITY CONTRACT.
- COORDINATE FIRE ALARM INTERFACE WITH ARCHITECTURAL LIFE SAFETY PLANS,
- PANEL AS REQUIRED. B. MINIMUM 8" LOW VOLTAGE SQUARE JUNCTION. LOW VOLTAGE JUNCTION WITH TERMINAL STRIP BY DOOR HARDWARE CONTRACT TO INTERCONNECT DOOR
- POCKET OR DOOR STRIKE WHERE REQUIRED.
- E. DOOR HARDWARE WITH REQUEST TO EXIT DEVICE / KEYPAD (CRASH BAR/ MORTISE) WHERE REQUIRED.
- I. POWERED DOOR OPERATOR WHERE REQUIRED.
- J. 3/4" BUSHED CONDUIT TO CR/WS/PP DEVICE BOX AND PLASTER RING. LOCATE CARD READER WITHIN 12" OF DOOR STRIKE UNLESS NOTED OTHERWISE, QTY. AS
- K. ELECTRIC STRIKE WHERE REQUIRED.
- L. LOCAL POWER SUPPLY WITH FIRE ALARM INTERFACE BY DOOR WITH 3/4" CONDUIT

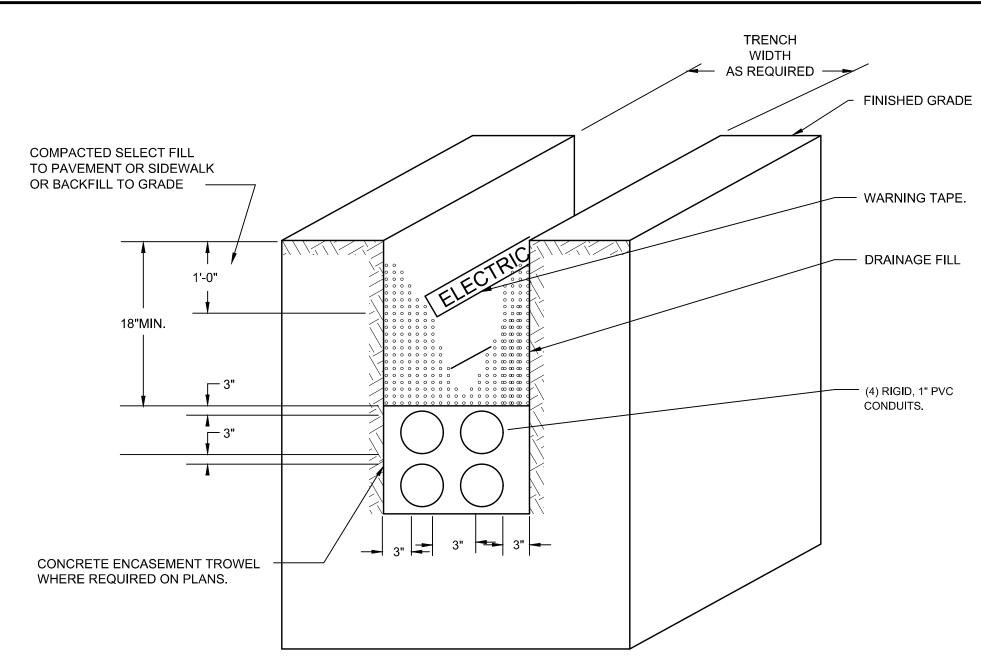

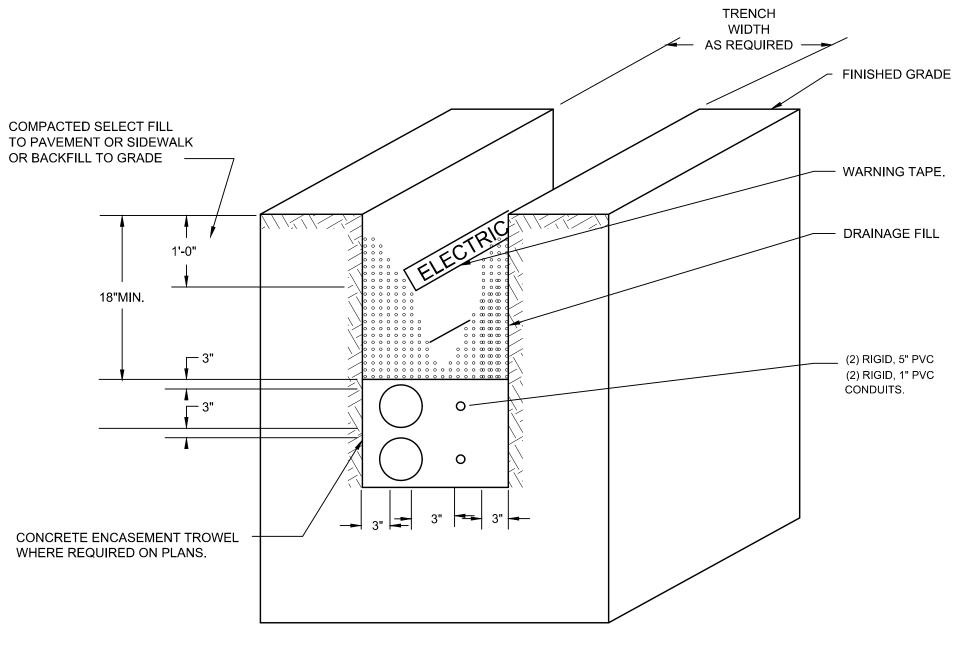

ELECTRICAL DUCT BANK DETAIL-CONTROLS




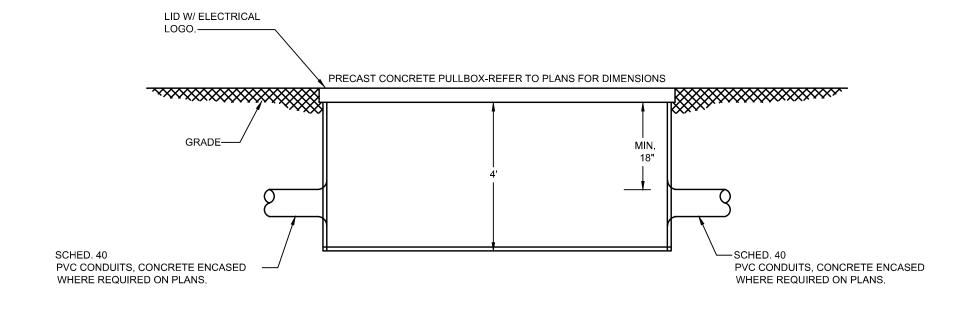

LID W/TELECOM PRECAST CONCRETE PULL BOX 4'X4'X2' ~~~~~~ <del>|</del> GRADE----SCHED. 80 PVC CONDUITS.— PVC CONDUITS.

C ELECTRICAL PULLBOX DETAIL

TELECOM PULLBOX DETAIL

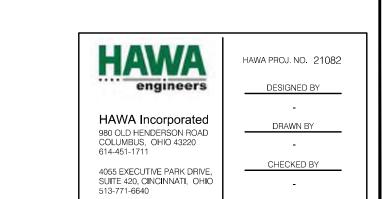

■ Landscape Architecture Cincinnati OH 45241

Suite 190B

Phone 513.759.0004

■ Engineering

■ Planning


■ Surveying

Project Manager CSW Drawn By E6 ELECTRICAL DETAILS X-Ref(s) Issue/Revision No. Date 08/15/2025 © Copyright 2025, McGILL SMITH PUNSHON, Inc.

**ELECTRICAL DETAILS** 

06308.12

Project Number AS NOTED Drawing Scale Sheet Number

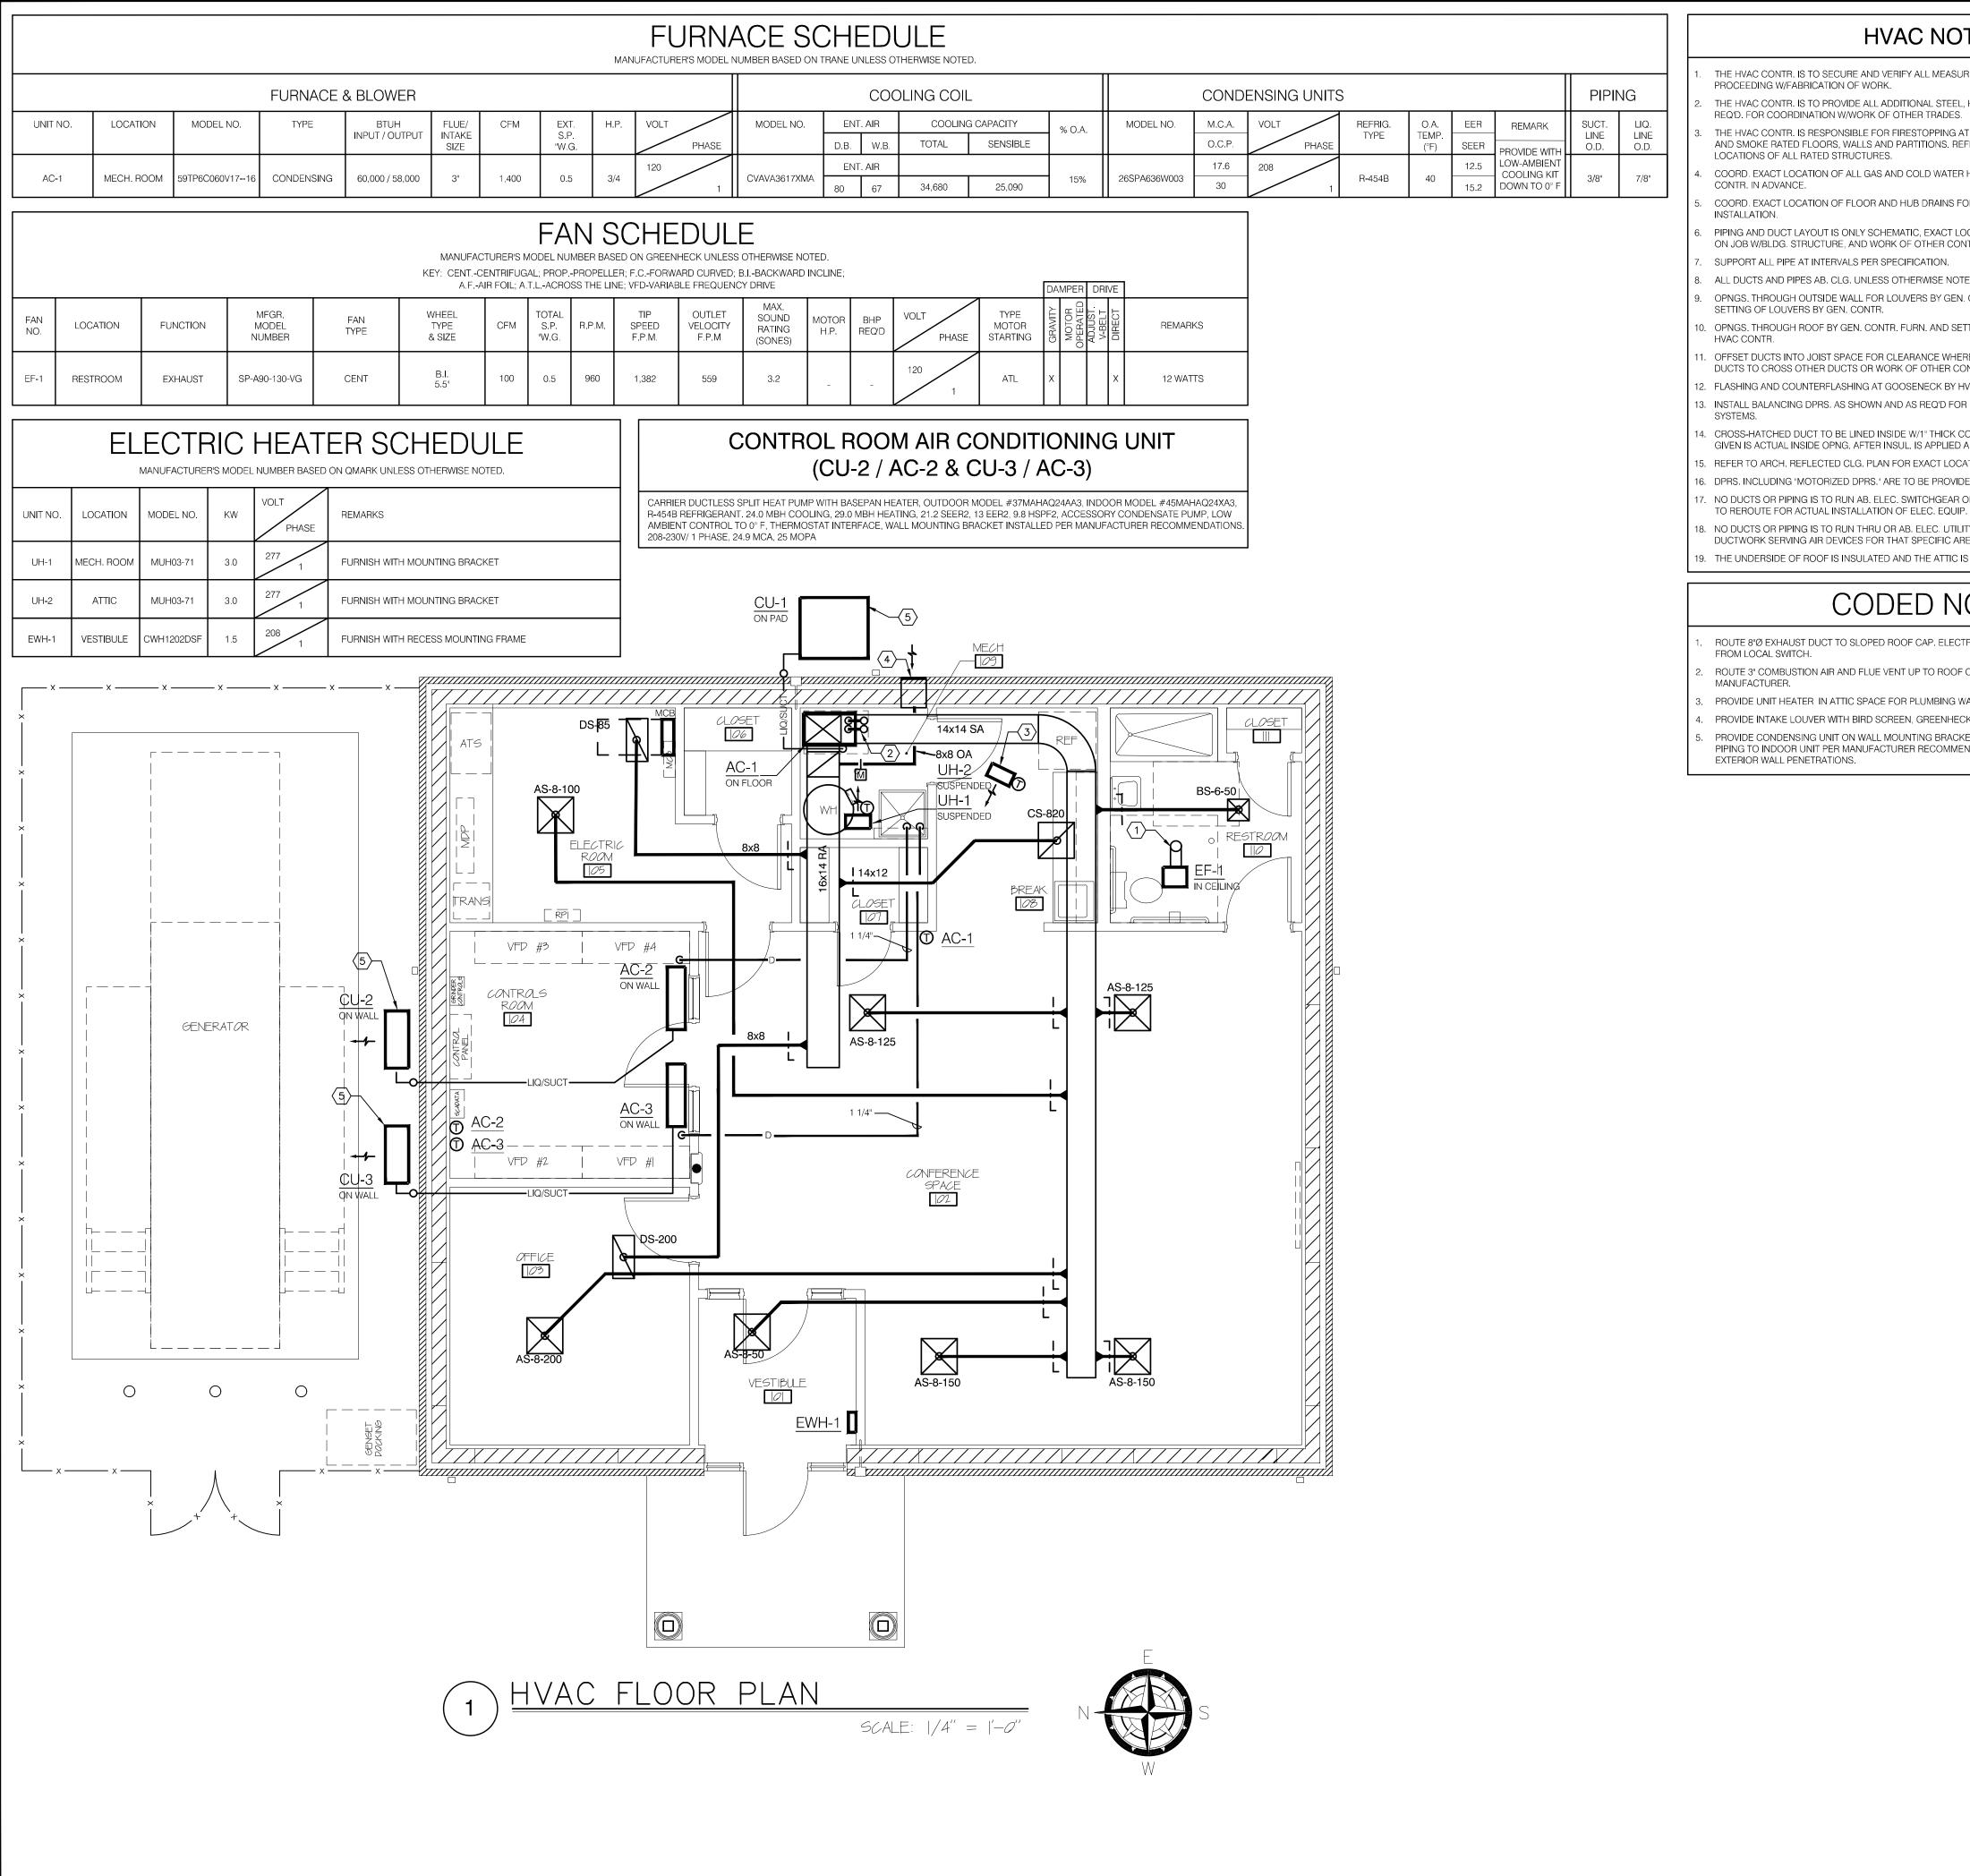

- THE HVAC CONTR. IS TO SECURE AND VERIFY ALL MEASUREMENTS AND CONDITIONS AT JOB BEFORE PROCEEDING W/FABRICATION OF WORK.
- THE HVAC CONTR. IS TO PROVIDE ALL ADDITIONAL STEEL, HANGER MATERIALS, RODS AND CLAMPS AS REQ'D. FOR COORDINATION W/WORK OF OTHER TRADES.
- THE HVAC CONTR. IS RESPONSIBLE FOR FIRESTOPPING AT ALL HVAC RELATED PENETRATIONS OF FIRE AND SMOKE RATED FLOORS, WALLS AND PARTITIONS. REFER TO ARCHITECTURAL FLR. PLANS FOR LOCATIONS OF ALL RATED STRUCTURES.
- COORD. EXACT LOCATION OF ALL GAS AND COLD WATER HVAC EQUIP. CONN'S. WITH THE PLUMBING
- COORD, EXACT LOCATION OF FLOOR AND HUB DRAINS FOR HVAC EQUIP, W/ PLBG, CONTR. PRIOR TO
- PIPING AND DUCT LAYOUT IS ONLY SCHEMATIC, EXACT LOCATION OF PIPES AND DUCTS TO BE COORD.
- ON JOB W/BLDG. STRUCTURE, AND WORK OF OTHER CONTRS. SUPPORT ALL PIPE AT INTERVALS PER SPECIFICATION.
- ALL DUCTS AND PIPES AB. CLG. UNLESS OTHERWISE NOTED.
- OPNGS. THROUGH OUTSIDE WALL FOR LOUVERS BY GEN, CONTR. ALL LINTELS AND WEATHERTIGHT
- ). OPNGS. THROUGH ROOF BY GEN. CONTR. FURN. AND SETTING OF PREFABRICATED CURBS AND FANS BY
- OFFSET DUCTS INTO JOIST SPACE FOR CLEARANCE WHERE SPACE AB. CLG. IS NOT SUFFICIENT FOR DUCTS TO CROSS OTHER DUCTS OR WORK OF OTHER CONTRS.
- FLASHING AND COUNTERFLASHING AT GOOSENECK BY HVAC CONTR.
- 8. INSTALL BALANCING DPRS. AS SHOWN AND AS REQ'D FOR PROPER BALANCING OF AIR HANDLING
- I. CROSS-HATCHED DUCT TO BE LINED INSIDE W/1" THICK COATED GLASS FIBER INSUL. DUCT DIMENSION GIVEN IS ACTUAL INSIDE OPNG. AFTER INSUL. IS APPLIED AND SHALL NOT BE SMALLER. REFER TO ARCH. REFLECTED CLG. PLAN FOR EXACT LOCATION OF DIFFUSERS, GRILLES, ETC.
- 6. DPRS. INCLUDING "MOTORIZED DPRS." ARE TO BE PROVIDED BY HVAC CONTR. NO DUCTS OR PIPING IS TO RUN AB. ELEC. SWITCHGEAR OR PANELS. MAKE ADJUSTMENTS NECESSARY
- B. NO DUCTS OR PIPING IS TO RUN THRU OR AB. ELEC. UTILITY, OR TELE. EQUIP. CLOSETS, EXCEPT FOR DUCTWORK SERVING AIR DEVICES FOR THAT SPECIFIC AREA.
- ). THE UNDERSIDE OF ROOF IS INSULATED AND THE ATTIC IS A CONDITIONED SPACE.

## CODED NOTES $\bigcirc$

- ROUTE 8"Ø EXHAUST DUCT TO SLOPED ROOF CAP. ELECTRICAL CONTRACTOR TO PROVIDE POWER
- ROUTE 3" COMBUSTION AIR AND FLUE VENT UP TO ROOF CONCENTRIC VENT, SUPPLIED BY FURNACE
- PROVIDE UNIT HEATER IN ATTIC SPACE FOR PLUMBING WATER PIPING FREEZE PROTECTION. PROVIDE INTAKE LOUVER WITH BIRD SCREEN, GREENHECK MODEL ESD-435-14"x10" OR EQUAL
- PROVIDE CONDENSING UNIT ON WALL MOUNTING BRACKET 3FT ABOVE GRADE. EXTEND REFRIGERANT PIPING TO INDOOR UNIT PER MANUFACTURER RECOMMENDATIONS. PROVIDE PIPE SLEEVES AT EXTERIOR WALL PENETRATIONS.

## **HVAC NOTES**

## SYMBOL DESCRIPTION ——— PIPE FLANGES **→ PIPE UNION** PENDANT TYPE SPRINKLER HEAD O UPRIGHT TYPE SPRINKLER HEAD OC P-TRAP (PLAN VIEW)

LOCATION

FLOOR OR AREA DRAIN

XC HOSE BIBB 45° BOOT BRANCH TAKEOFF THERMOSTAT CONNECT TO EXISTING POINT OF DISCONNECT THRU FLOOR AS SHOWN JANITOR OR SHOWER FAUCET/

丞 GATE VALVE (SCREWED BODY) **⋈** COMB. BALANCE & STOP VALVE ~ CHECK VALVE SPIN-IN FITTING W/ BALANCE SUPPLY DUCT UP  $\sim$ SUPPLY DUCT DOWN RA, OA, OR EXH. DUCT UP R.A., O.A., OR EXH. DUCT DOWN ELBOW WITH TURNING VANES <del>| \</del> MANUAL DAMPER Ь Y-TYPE STRAINER

DESCRIPTION

GAS COCK OR BALANCE VALVE

BALL VALVE


— CW — DOMESTIC COLD WATER LINE 


MECHANICAL LEGEND

 $\sqrt{}$ 

## HVAC ABBREVIATIONS

AB.         ABOVE         HTG.         HEATING           A.D.         ACCESS DOR         H 8 AVC         HEATING AND AIR CONDITIONING           A.F.F.         ABOVE PRISHED FLOOR         H 8 C         HEATING AND AIR COOLING           APPROX.         APPROXIMATELY         H 8 V         HEATING AND VENTILATING           APPROX.         APPROXIMATELY         H V.         HIGH PATTY           AUTOMATIC CONTROL         IND.         HIGH PATTY         HIGH PATTY           BBD.         RAD.         MANAL DAMPER         HEATING AND VENTILATING           BLDC.         BUILDING         MRCH.         MICH PATTY         MICH PATTY           BLDC.         BUILDING         MRCH.         MECHANICAL         MCHANICAL         MCHANICAL <td< th=""><th></th><th></th><th></th><th></th></td<>				
AFF.         ABOVE FINISHED FLOOR         H & C         HEATING AND COOLING           APPROX.         APPROXIMATELY         H & V         HEATING AND VENTILATING           ARCH.         ARCHIECT         H.V.         HIGH VELOCITY           AUTO, CONT.         AUTOMATIC CONTROL         IND. U.         INDUCTION UNIT           BSBD RAD.         BASEBOARD RADIATION         MR.D.PR.         MANUAL DAMPER           BTM.         BOTTOM         MFR.         MANUAL DAMPER           BLDG.         BUILDING         MECH.         MECHANICAL           BLDG.         BUILDING         MECH.         MECHANICAL           CAB.         CABINET         M.A.         MIXED AIR           CAP.         CAPACITY         MTD.         MOUNTED           CLG.         CEILING         NOM.         NOMINAL           CONC.         CONCRETE         OPNG.         OPENING           CONT.         CONTRACTOR         PLBG.         PLUMBING           CONT.         CONTRACTOR         PLBG.         PLUMBING           CONT.         CONTRACTOR         P.R.V.         PRESSURE REDUCING VALVE           COND.         CORDINATE         PROP.         PROPELLER           DTL.         DETAIL	AB.	ABOVE	HTG.	HEATING
APPROX. APPROXIMATELY ARCH. ARCHITECT AUTO. CONT. AUTOMATIC CONTROL BSBD. RAD. BASEDOARD RADIATION BSBD. RAD. BOSTOM BILLONG BILLONG BLILLONG BLILLONG CAB. CABINET CAP. CAPACITY MITD. MOUNTED CONN. CONCETE CONN. CONCETE CONN. CONNECT CONN. CONNECT CONTROL CONT. CONTRACTOR PEBS. PRESSURE CONV. CONSECTOR COND. COORDINATE DTAL DETAIL DIAL DIAM DIAM DIAM DIAM DIAM DIAM DIAM DIAM	A.D.	ACCESS DOOR	H & A/C	HEATING AND AIR CONDITIONING
ARCH. ARCHITECT H.V. HIGH VELOCITY AUTO. CONT. AUTOMATIC CONTROL. IND. U INDUCTION UNIT BSBD RAD. BASEBOARD RADIATION MAN. DPR. MANUAL DAMPER BTM. BOTTOM MFR. MANUACTURER BLDC. BUILDING MECH. MECHANICAL CAB. CABINET M. A MIXED AIR CAP. CAPACITY MTD. MOUNTED CLG. CEILING NOM. NOMINAL CONC. CONCRETE OPNG. OPENING CONN. CONTRACTOR PLBG. PLUMBING CONT. CONTRACTOR PLBG. PLUMBING CONT. CONTRACTOR P.R.V. PRESSURE REDUCING VALVE COORD. COORDINATE PROP. PROPELLER DTL. DETAIL RAD. RADIATOR DIFF. DIFFUSER REG. REGISTER DISCH. DISCHARGE RHC. RELEAT COIL DN. DOWN REOD. REQUIRED ELEC. ELECTRICAL REL ELEM. ELEMENT R.A RETURN AIR ELEV. ELEVATION RM. ROOM EXH EXHAUST SCHED. SCHEDULE EXIST. EXISTING SHITMILL SHEET METAL FT. HD. FEET OF HEAD FIRST SA SUPPLY AIR FLEX. FLEXIBLE S.A S.R SUPPLY AIR FLEX. FLEXIBLE S.A SUPPLY AIR FLEX. FLEXIBLE S.	A.F.F.	ABOVE FINISHED FLOOR	H&C	HEATING AND COOLING
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BIM. BOTTOM MECH. MANUFACTURER BLDG. BUILDING MECH. MECHANICAL CAB. CABINET M. A. MIXED AIR CAP. CAPACITY MID. MOUNTED CLG. CEILING NOM. NOMINAL CONC. CONCRETE OPNG. OPENING CONN. CONNECT O.A. OUTSIDE AIR CONT. CONTRACTOR PLBG. PLUMBING CONT. CONTRACTOR PRESS. PRESSURE CONV. CONVECTOR P.R.V. PRESSURE REDUCING VALVE COORD. COORDINATE PROP. PROPELLER DIL DETAL RAD. RADIATOR DIFF. DIFFUSER REG. REFRIGERATION DIFF. DIFFUSER REG. REGISTER DISCH. DISCHARGE RHC. RELE DIN. DOWN REOD. REQUIRED ELEC. ELECTRICAL REL. RELIEF ELEM. ELEMENT R.A. RETURNAIR ELEV. ELEVATION RM. ROOM EXH EXHAUST SCHED. SCHEDULE EXIST. EXISTING SHT.MITL. SHEET METAL FT. HD. FEET OF HEAD SQ. SQUARE FIN. RAD. FINNED RADIATION STAT. THERMOSTAT F. APR. FIRE DAMPER S.A. SUPPLY AIR RETURN FETTIN FLEX. FLEXIBLE F. A.T FLOAT AND THERMOSTATIC FLEX. GAGE GENERAL GEN. GENERAL GRAV. GRAVITY VIB. ISOL. VIBRATION ISOLATOR	AUTO CONT.	AUTOMATIC CONTROL	IND. U.	INDUCTION UNIT
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CAP. CAPACITY CLG. CEILING CONC. CONCRETE CONN. CONNECT CONN. CONTRACTOR CONTR. CONTRACTOR CONT. CONTRACTOR CONV. CONVECTO CONV. CONVECTOR CONV. CONVECTOR CONV. CONVECTOR CONV. CONVECTOR CORD. COORDINATE CONT. COORDINATE CONT. COORDINATE CONT. COORDINATE CONV. COORDINATE COORDI	BLDG.	BUILDING	МЕСН.	MECHANICAL
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CONC.  CONCRETE  CONN.  CONNECT  CONTR.  CONTRACTOR  PLBG.  PLUMBING  PRESS.  PRESSURE  CONV.  CONVECTOR  P.R.V.  PRESS.  PRESSURE  PROP.  PROPELLER  DIL.  DETAIL  DETAIL  DIAMETER  DIFFUSER  DISCH.  DISCHARGE  DIN.  DOWN  REGD.  REGUIRED  BLEC.  ELECTRICAL  ELEM.  ELEM.  ELEW.  ELEV.  ELEVATION  EXH  EXHAUST  EXIST.  EXISTING  FIT. HD.  FEET OF HEAD  FIN. AD.  FI	CAP.	CAPACITY	MTD.	MOUNTED
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	GRAV.	GRAVITY	VIB. ISOL.	VIBRATION ISOLATOR
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	HTR.	HEATER	W/	WITH

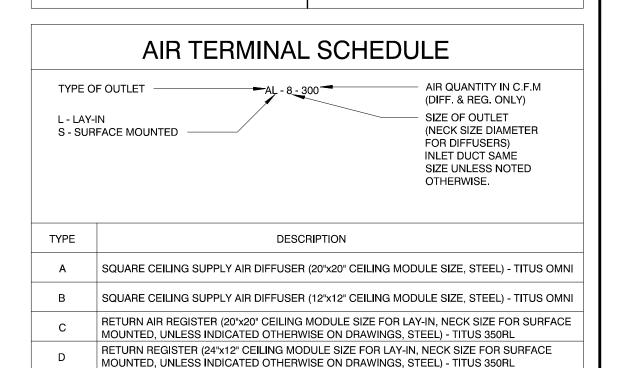

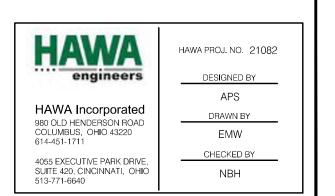



3700 Park 42 Drive

Cincinnati OH 45241

Suite 190B

■ Architecture

■ Engineering

■ Landscape Architecture

Sheet:q:\2021\21082\Drawings\Sheets\H1 HVAC FLOOR PLAN, NOTES, & SCHEDULES.dwg Plot:8/13/2025 1:42 PM User:APS

■ Planning Phone 513.759.0004 ■ Surveying www.mspdesign.com **Project Manager** CSW Drawn By X-Ref(s) Issue/Revision No. Date BID/PERMIT 08/15/2025

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Sheet Title

HVAC FLOOR PLAN, NOTES, & SCHEDULES

06308.12

AS NOTED

Project Number Drawing Scale Sheet Number

## VFD #3 | VFD #4 CONTROLS ROOM 104 VFD #2 | VFD #| CONFERENCE SPACE 102 OFFICE 3/4" CW DN TO 48" BELOW SLAB — $\circ$ VESTIBULE 3/4" CW 48" BELOW GRADE, SEE SITE UTILITY PLAN FOR CONTINUATION PLUMBING FLOOR PLAN

## PLUMBING NOTES

- ALL PIPING SHOWN IS AB. CLG. IN AREAS WITH DROPPED CLG'S., OR AT BTM. OF SUPPORT STRUCT. FOR FLR. OR ROOF AB. IN EXPOSED STRUCT. AREAS, UNLESS NOTED OTHERWISE.
- THE PLBG. CONTR. IS TO SECURE AND VERIFY ALL MEASUREMENTS AND CONDITIONS AT JOB BEFORE PROCEEDING W/FABRICATION OF WORK.
- THE PLBG. CONTR. IS TO PROVIDE ALL ADDITIONAL STEEL, HANGER MATERIALS, RODS AND CLAMPS AS REQ'D. FOR COORDINATION W/WORK OF OTHER TRADES.
- THE PLBG. CONTR. IS RESPONSIBLE FOR FIRESTOPPING AT ALL PLBG. RELATED PENETRATIONS OF FIRE AND SMOKE RATED FLOORS, WALLS AND PARTITIONS. REFER TO ARCHITECTURAL FLR. PLANS FOR LOCATIONS OF ALL RATED STRUCTURES.
- PIPING LAYOUT IS ONLY SCHEMATIC, EXACT LOCATION OF PIPES TO BE COORD. WITH BLDG. STRUCTURE AND WORK OF OTHER CONTRS.
- 6. CONCEAL PIPING WHENEVER POSSIBLE UNLESS NOTED OTHERWISE.
- COORD. EXACT LOCATION OF ALL GAS AND COLD WATER HVAC EQUIP. CONN'S. WITH THE HVAC CONTR.
- . COORD. EXACT LOCATION OF FLOOR AND HUB DRAINS FOR HVAC EQUIP. W/ HVAC CONTR. PRIOR TO INSTALLATION.
- 9. RUN ALL WATER AND GAS LINES LEVEL.
- 10. ROUGH IN ALL PIPING THRU FACE OF WALL WHERE POSSIBLE, EXCEPT IN OUTSIDE WALLS. TERMINATE W/ SHORT NIPPLE AND CAP.
- 11. WORK SHALL BE INSTALLED IN ACCORDANCE W/ THE STATE OF OHIO PLUMBING CODE.
- 12. PROVIDE CLEANOUTS AT NOT MORE THAN 100 FT. APART IN HORIZONTAL SANITARY DRAINAGE LINES. 13. PROVIDE CLEANOUTS AT EACH CHANGE OF DIRECTION GREATER THAN 45° IN THE BLDG. DRAIN (SAN.
- PIPING BELOW FLR. SLAB).
- 14. INSTALL TEST CLEANOUTS AT CONN'S. TO EXIST. SAN. SYSTEMS.
- 15. ALL FIXTURES TO BE EQUIPPED. WITH STOP VALVES IN ACCESSIBLE LOCATION.
- 16. INSTALL ALL EXTERIOR HOSE BIBBS APPROX. 20" AB. GRADE.
- 7. UNLESS OTHERWISE SHOWN ON DWGS., THIS CONTR. SHALL BE RESPONSIBLE FOR SIZING DOMESTIC WATER PIPING IN CHASES, ETC. TO INDIVIDUAL FIXTURES. WHEN PIPING SERVES FLUSH VALVES, COLD WATER PIPE SHALL EXTEND FULL SIZE TO END OF PIPE CHASE RUN AND A SHOCK ABSORBER INSTALLED. WHEN COLD WATER PIPE IS 2" OR AB. AND SERVES FLUSH VALVES, PIPE MAIN IN CHASE CAN ONLY BE REDUCED TO 1 1/2" SIZE. 1/2" HOT WATER PIPE SHALL SERVE UP TO FOUR (4) LAVS. OTHER PIPE SIZING CRITERIA SHALL BE AS OUTLINED IN THE LATEST EDITION OF THE "ASHRAE FUNDAMENTALS
- 8. VERIFY THE EXACT LOCATION OF ALL DRAINS WITH THE ARCH. AND STRUCTURAL DWG'S. FOR PROPER PLACEMENT IN RESPECT TO SLOPES AND COORD. W/SUPPORT STRUCT. COORD. INSTALLATION W/ THE APPROPRIATE CONTR.
- 19. UNLESS INDICATED OTHERWISE, BUILDING DRAIN (STORM, SANITARY, ETC.) CONN. ARE PROVIDED AT 5 FT. BEYOND FACE OF EXTERIOR STRUCTURE. COORDINATE LOCATION (INCLUDING INVERT ELEVATION) WITH THE SITE UTILITY CONTRACTOR.
- 0. UNLESS INDICATED OTHERWISE, BUILDING DOMESTIC/F.P. WATER SERVICE CONNECTIONS ARE PROVIDED AT 12" ABOVE FLOOR. COORDINATE LOCATION(S) WITH THE SITE UTILITY CONTRACTOR.
- 1. VERIFY EXACT LOCATIONS, SIZES AND UTILITY CONN'S. OF OWNER FURN'D. EQUIP. FOR PROPER PLACEMENT OF DRAINS AND UTILITY SERVICE CONN'S.
- 22. NO LIQUID TRANSMISSION PLBG. UTILITY PIPING IS TO RUN AB. ELEC. SWITCHGEAR OR PANELS. MAKE ADJUSTMENTS NECESSARY TO REROUTE PIPING FOR ACTUAL INSTALLATION OF ELEC. EQUIP.

3. NO LIQUID TRANSMISSION PLBG. UTILITY PIPING IS TO RUN THRU OR AB. ELEC. UTILITY, TELE. EQUIP. OR

- ELEVATOR MACHINE RM'S. OR CLOSETS (INCLUDING ELEVATOR SHAFTS), EXCEPT FOR PIPING SERVING EQUIP. OR DEVICES FOR THAT SPECIFIC AREA. PROVIDE DRIP PANS BELOW ANY LIQUID TRANSMISSION PIPING THAT IS REQ'D. IN THESE AREAS. 4. ALL FLOOR DRAINS LOCATED IN REST ROOMS THAT ARE DIRECTLY CONNECTED TO THE SANITARY
- WASTE SYSTEM SHALL BE SUPPLIED WITH A TRAP PRIMER LINE FROM THE NEAREST WATER CLOSET FLUSH VALVE, UNLESS INDICATED OTHERWISE ON THE DWGS.
- 5. SANITARY AND VENT SIZES INDICATED ON DRAWINGS ARE MINIMUM NOMINAL PIPE SIZE. IF PIPING MATERIAL IS NOT READILY AVAILABLE IN SIZES INDICATED, THE CONTRACTOR MAY, AT THEIR OPTION, PROVIDE PIPING AT THE NEXT NOMINAL SIZE LARGER. UNDER NO CIRCUMSTANCES SHOULD SIZES BE REDUCED FROM THOSE INDICATED ON DWGS.
- 26. THE UNDERSIDE OF THE ROOF IS INSULATED AND THE ATTIC IS A CONDITIONED SPACE. 27. ONLY SANITARY PIPING IS ALLOWED BELOW SLAB WITHIN THE BUILDING. ALL OTHER PIPING SHALL BE
- ROUTED IN THE ATTIC.

## CODED NOTES $\bigcirc$

- EXTEND SANITARY LINE TO MAIN. REFER TO SITE PLAN FOR CONTINUATION.
- PROVIDE 4" GATE TYPE BACKWATER VALVE, SIMILAR TO ZURN MODEL Z-1088. PROVIDE WITH EXTENSION SO THAT VALVE MAY BE OPERATED FROM FLOOR.
- NATURAL GAS METER BY GAS COMPANY. GAS PRESSURE DELIVERED BY GAS COMPANY IS 2 PSI. REGULATE DOWNSTREAM GAS PRESSURE TO 11" W.G.
- PROVIDE WATER METER AND BACKFLOW ASSEMBLY PER WATER DEPARTMENT
- REQUIREMENTS.
- EXTEND COLD WATER PIPE DOWN WALL TO PLUMBING FIXTURES. EXTEND 1" TO WC-1, 1/2" TO S-1, 1/2" TO LAV-1, 1/4" TO WATER SUPPLY BOX, AND 1/2" TO SH-1.
- . EXTEND HOT WATER PIPE DOWN WALL TO PLUMBING FIXTURES. EXTEND 1/2" TO <u>S-1</u>, 1/2" TO <u>LAV-1</u>, AND 1/2" TO <u>SH-1</u>.
- PROVIDE COLD WATER SUPPLY BOX FOR REFRIGERATOR SUPPLY (OATEY 12K OR EQUAL). CONNECT TO OWNER FURNISHED WATER FILTER.
- COLD WATER PIPING IN ATTIC TO BE HEAT TRACED. HEAT TRACING FURNISHED AND INSTALLED BY ELECTRICAL CONTRACTOR. COORDINATE WITH ELECTRICAL CONTRACTOR PRIOR TO INSULATING PIPING.
- ROUTE 3" COMBUSTION AIR AND FLUE VENT UP TO ROOF CONCENTRIC VENT, SUPPLIED BY WATER HEATER MANUFACTURER.
- 0. PROVIDE 1" COLD WATER DOWNSTREAM OF BACKFLOW PREVENTER INSIDE MECHANICAL ROOM. PROVIDE WITH SHUT-OFF VALVE AND CHECK VALVE PRIOR TO ROUTING UNDERGROUND. REFER TO SITE UTILITY PLAN FOR CONTINUATION TO YARD

## PLUMBING ABBREVIATIONS


AB.	ABOVE	H.B.	HOSE BIBB
A.F.F.	ABOVE FINISHED FLOOR	HTR.	HEATER
APPROX.	APPROXIMATELY	HTG.	HEATING
BTM.	BOTTOM	INV. ELEV.	INVERT ELEVATION
BLDG.	BUILDING	INT.	INTERIOR
B.T.	BATH TUB	J.R.	JANITORS RECEPTOR
C.B.	CATCH BASIN	LAV.	LAVATORY
C.D.	CANOPY DRAIN	M.H.	MANHOLE
СНЕМ.	CHEMICAL	MFR.	MANUFACTURER
C.I.	CAST IRON	MECH.	MECHANICAL
CLG.	CEILING	PLBG.	PLUMBING
CONC.	CONCRETE	PRESS.	PRESSURE
C.O.	CLEAN OUT	REQD.	REQUIRED
CONN.	CONNECT	R.D.	ROOF DRAIN
CONTR.	CONTRACTOR	RM.	ROOM
DTL.	DETAIL	S.D.	SHOWER DRAIN
DIA.	DIAMETER	SH.	SHOWER
D.F.	DRINKING FOUNTAIN	S.I.	SURFACE INLET
DN.	DOWN	S.S.	SERVICE SINK
D.S.	DOWNSPOUT	THERM.	THERMOMETER
ELEC.	ELECTRICAL	T.P.	TRAP PRIMER
E.W.C.	ELECTRIC WATER COOLER	TYP.	TYPICAL
EXIST.	EXISTING	UR.	URINAL
EXT.	EXTERIOR	VAC.	VACUUM
FT. HD.	FEET OF HEAD	V.S.P.	VITRIFIED SEWER PIPE
FLR.	FLOOR	V.T.R.	VENT THRU ROOF
F.D.	FLOOR DRAIN	W.	WASTE
FURN.	FURNISH	W/	WITH
F.V.	FLUSH VALVE	WC	WATER CLOSET
GEN.	GENERAL	W.C.O.	WALL CLEAN OUT

## PLUMBING LEGEND DESCRIPTION SYMBOL DRAIN VALVE WITH CAPPED HOSE END

LAB OUTLET C-P-TRAP (PLAN VIEW) GLOBE VALVE CAPPED LINE GATE VALVE (FLANGED BODY) —C RISE OR DROP SOLENOID VALVE **X**C HOSE BIBB CHECK VALVE PIPE BRANCH BOTTOM GAS COCK OR BALANCE VALVE CONNECTION **BUTTERFLY VALVE** PIPE FLANGES FLOOR OR AREA DRAIN —| | — PIPE UNION Y-TYPE STRAINER THERMOMETER PETE'S PLUG CURB BOX AND VALVE CONNECT TO EXISTING COMB BALANCE AND STOP VALVE BALL VALVE THRU FLOOR AS SHOWN GATE VALVE (SCREWED BODY) DISCONNECT FROM EXISTING JANITOR OR SHOWER FAUCET/HEAD LOCATION

## WATER HEATER SCHEDIII E

WATER REATER SCREDULE						
HEATER NO.	LOCATION	MFGR MODEL NUMBER	STORAGE CAPACITY GALLONS	TYPE OF GAS	INPUT RATING BTU/HR	RECOVERY RATE AT 100°F T.R.
WH-1	MECH. ROOM	BTH-120	60	NATURAL	120,000	138 GAL/HR

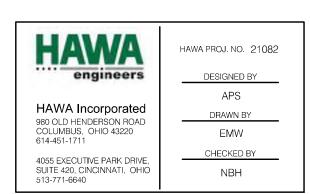



■ Architecture

■ Engineering

■ Planning

■ Surveying

3700 Park 42 Drive Suite 190B ■ Landscape Architecture Cincinnati OH 45241 Phone 513.759.0004 www.mspdesign.com

**Project Manager** CSW Drawn By X-Ref(s)

Issue/Revision No. Date BID/PERMIT 08/15/2025 C) Copyright 2025, McGILL SMITH PUNSHON, Inc


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PLUMBING FLOOR PLAN, NOTES, & SHEDULE


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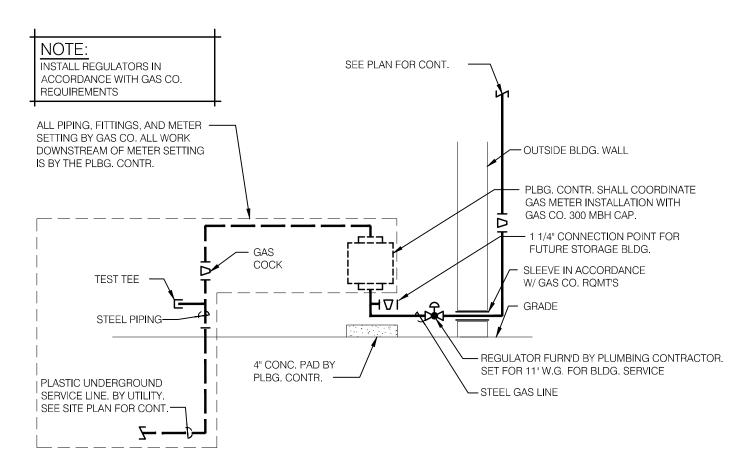
Sheet:q:\2021\21082\Drawings\Sheets\P1 PLUMBING FLOOR PLAN, NOTES, SCHEDULES & DETAILS.dwg Plot:8/13/2025 12:31 PM User:APS




UNDERCOUNTER PIPING DETAIL
NO SCALE

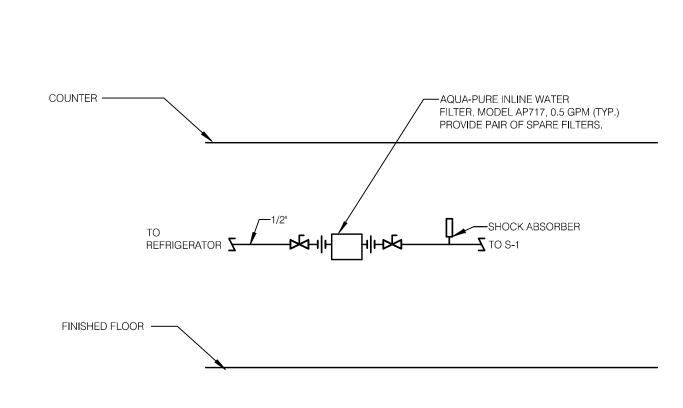


WATER HEATER DIAGRAM NO SCALE

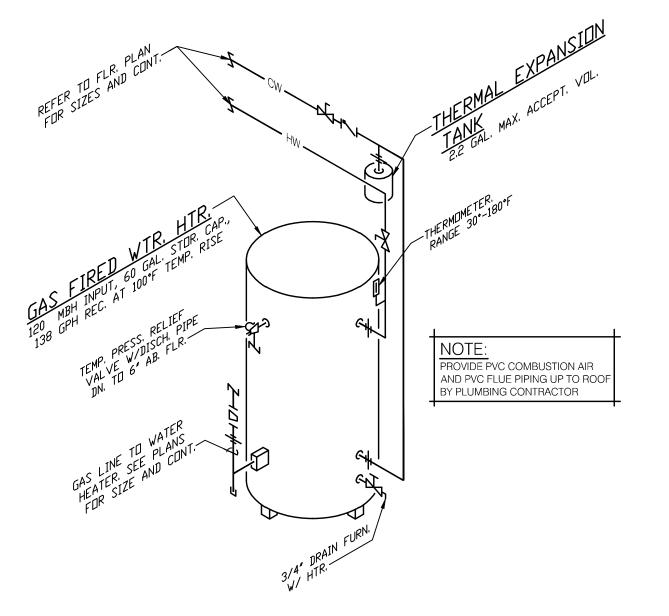

GAS METER & REGULATOR DIAGRAM

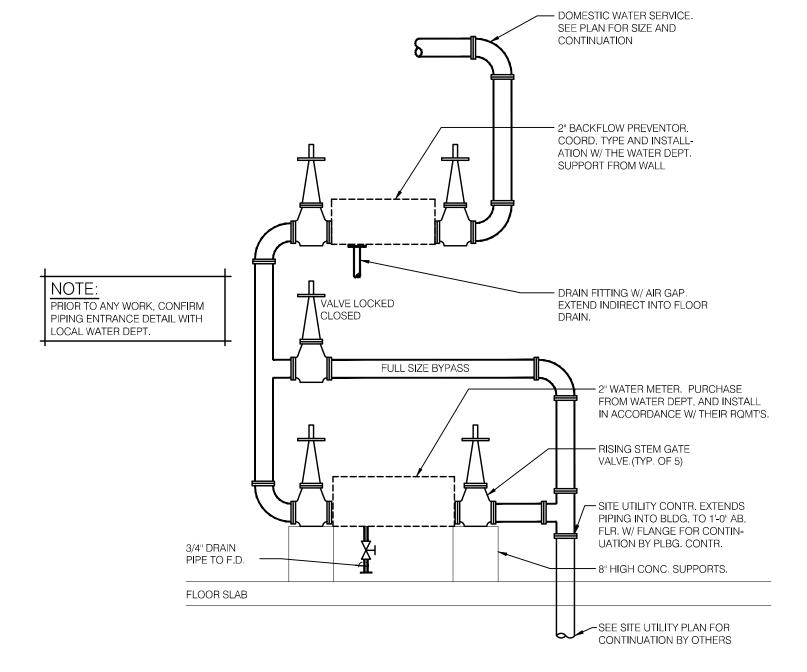

DOMESTIC WATER SERVICE ENTRANCE DETAIL
NO SCALE

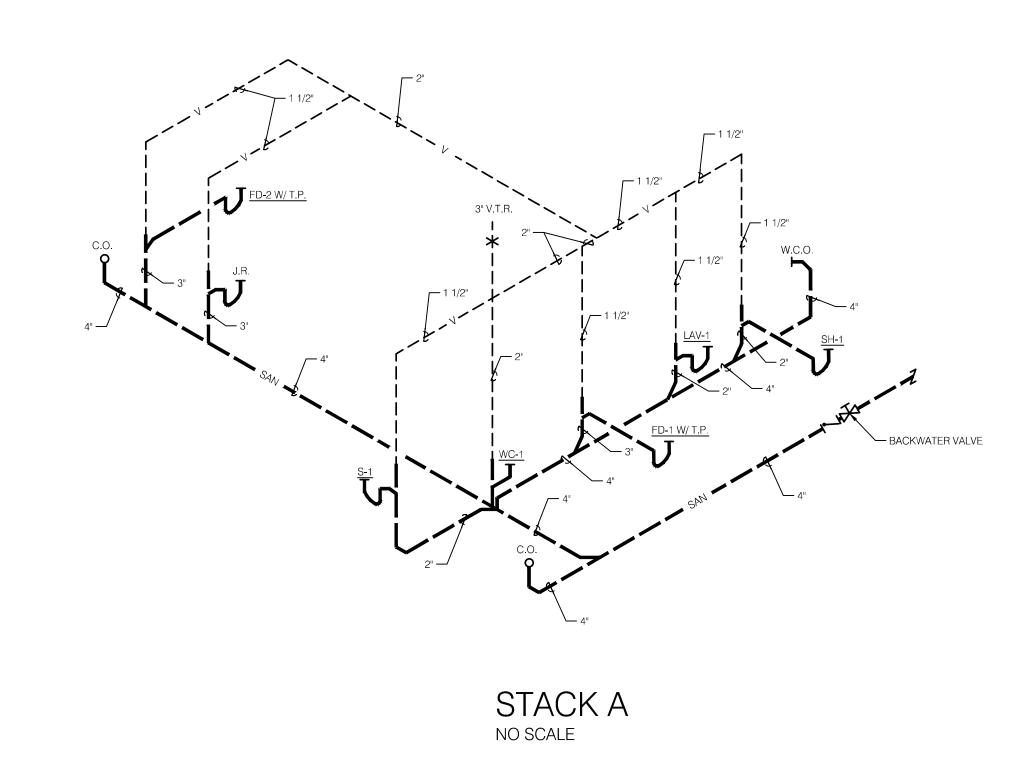



DESIGN

McGill Smith Punshon

Architecture
Engineering
Suite 1908
Landscape Architecture
Cincinnati OH 45241

Project Manager DCC
Drawn By CSW
DWG

Phone 513.759.0004

■ Planning

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